### TOWN OF WESTPORT REGULAR PLAN COMMISSION MEETING Kennedy Administration Building Community Meeting Room 5387 Mary Lake Road Town of Westport, Wisconsin

AGENDA - February 14, 2022 7:00 p.m.

This meeting is being noticed as a possible gathering of a quorum of the Westport Town Board due to the possible attendance of Supervisors not appointed to the Commission. Supervisors may discuss items on this agenda, or gather information on these items, but no action will be taken on these items as the Town Board.

- 1. Call to Order
- 2. Public Comment on Matters Not On the Agenda
- 3. Approve Minutes
- 4. Design Review, Lake Pointe Apartments Improvements, Lake Pointe Associates, Westport Road (Town Zoning), Discussion/Action
- 5. Consultation, Land Division and Rezone (Create 2-3 Single Family Residential Lots), Nonn, Wegenke Property Near Briggs Road, CTH Q (Middleton ETZ)
- 6. Park Committee Report/Items for Action
- 7. Historic Preservation Commission Report/Items for Action
- 8. Waunakee/Westport Joint Planning Committee Report/Items for Action
- 9. Middleton/Westport Joint Zoning Committee Report/Items for Action
- 10. Miscellaneous Matters/Forthcoming Events
- 11. Adjourn

If you need reasonable accommodations to access this meeting, please contact the clerk's office at 849-4372 at least three business days in advance so arrangements can be made to accommodate the request.

### TOWN OF WESTPORT

## PLAN COMMISSION - January 10, 2022

The regular monthly meeting of the Plan Commission was called to order at 7:04 p.m. in the Community Meeting Room of the Bernard J. Kennedy Administration Building by Chair Grosskopf. Members present: Bruskewitz, Cuccia, Grosskopf, Manering, Ohm, Pichette. Members absent: Kennedy. Also attending: Terry Enge, Mark Trotter, Sam Ballweg, Ron and Vic Pulvermacher, and Tom Wilson.

No one was present for Public Comment on Matters not on the Agenda. The minutes of the December 13, 2021 regular meeting were approved as presented on a motion by Manering, second Cuccia.

An Initial Consultation for potential Rezones for Commercial/Industrial Use, Pulvermacher Farm, 5980 STH 113 (Waunakee ETZ), was then held. After an introduction by Wilson, comments from the owners, and discussion, the owners were told of issues with the development of the property east of STH 113 under the current Comprehensive Plan.

Wilson reported the work of the Park Committee. Pichette reported on the work of the Historic Preservation Commission, and based on action at its meeting as reported the Plan Commission requested Town Staff to support the Holy Wisdom Monastery in its current barn preservation project on a motion by Bruskewitz, second Pichette.

Grosskopf and Wilson reported on the work of the Waunakee/Westport Joint Planning Committee and Middleton/Westport Joint Zoning Committee.

There were no Miscellaneous Matters or Forthcoming Events raised.

Motion to adjourn by Bruskewitz, second Manering. The meeting adjourned at 8:01 p.m.

Mary Manering, Secretary

## AGENDA ITEM #4:

Design Review, Lake Pointe Apartment Improvements, Lake Pointe Associates, Westport Road (Town Zoning), Discussion/Action



Town of Westport GIS



Town of Westport 5387 Mary Lake Road Waunakee, WI 53597 (608) 849-4372

DISCLAIMER: The Town of Westport does not guarantee the accuracy of the material contained here in and is not responsible for any misuse or misrepresentation of this information or its derivatives.

Print Date: 2/9/2022

From: Don Schroeder <DSchroeder@knothebruce.com> Sent: Wednesday, January 26, 2022 9:54 AM To: Robert Anderson <banderson@townofwestport.org> Cc: Kevin Burow <KBurow@knothebruce.com>; Arianna Wolske <awolske@knothebruce.com> Subject: FW: lake pointe Submittal

Dear Mr. Anderson,

Attached is our design review submittal for proposed alterations to Lake Pointe Apartments at 5324 Westport Road.

Our client and property owner Lake Point Associates, LLP are seeking approvals to construct additional common amenities to the existing development to help

In the leasing of their apartments.

The amenities include a new office/exercise building, a new pool with a pool building and grilling gazebo, a dog run area, a storage shed and a firepit with connecting walks.

If you require additional information or have any comments, please contact me or Craig Enzenroth.

Thanks, Donald Schroeder

Donald Schroeder, AIA, l Architect l Knothe & Bruce Architects, LLC l Ph: 608.836.3690 7601 University Avenue, Middleton, WI 53562 l dschroeder@knothebruce.com

## TOWN OF WESTPORT DESIGN REVIEW APPLICATION GENERAL INFORMATION

Project:	Lake Pointe Apartments - Improvements
Name:	Lake Pointe Associates, LLP
Address:	5320-22, 5324-26, 5312-14, 5316-18 Westport Rd
	Madison, WI 53704

## **Applicant:**

Name:	Lake Pointe Associates, LLP	Craig Enzenroth
Address:	101 E Main St., Suite 500	
	Mt Horeb, WI 53572	
Phone:	608-237-1300	
Email:	cenzenroth@gallinacos.com	


## **Representative:**

Name:	Knothe & Bruce Architects - Don Schroeder
Address:	7601 University Ave
-	Middleton, WI 53562
Phone:	608-836-3690
Email:	DSchroeder@knothebruce.com

Date Submitted:	
Review Period Ends:	
Period Extended To:	
Date of Plan Commission meetings:	
Time of meeting:	


I agree that the following information is true to the best of my knowledge, and to abide by Town of Westport Ordinance Provisions.

By:	Craig Enzenroth	Digitally signed by Craig Enzenroth Date: 2022.01.24 14:38:19 -06'00'	BN
Date: _	1/24/2022		

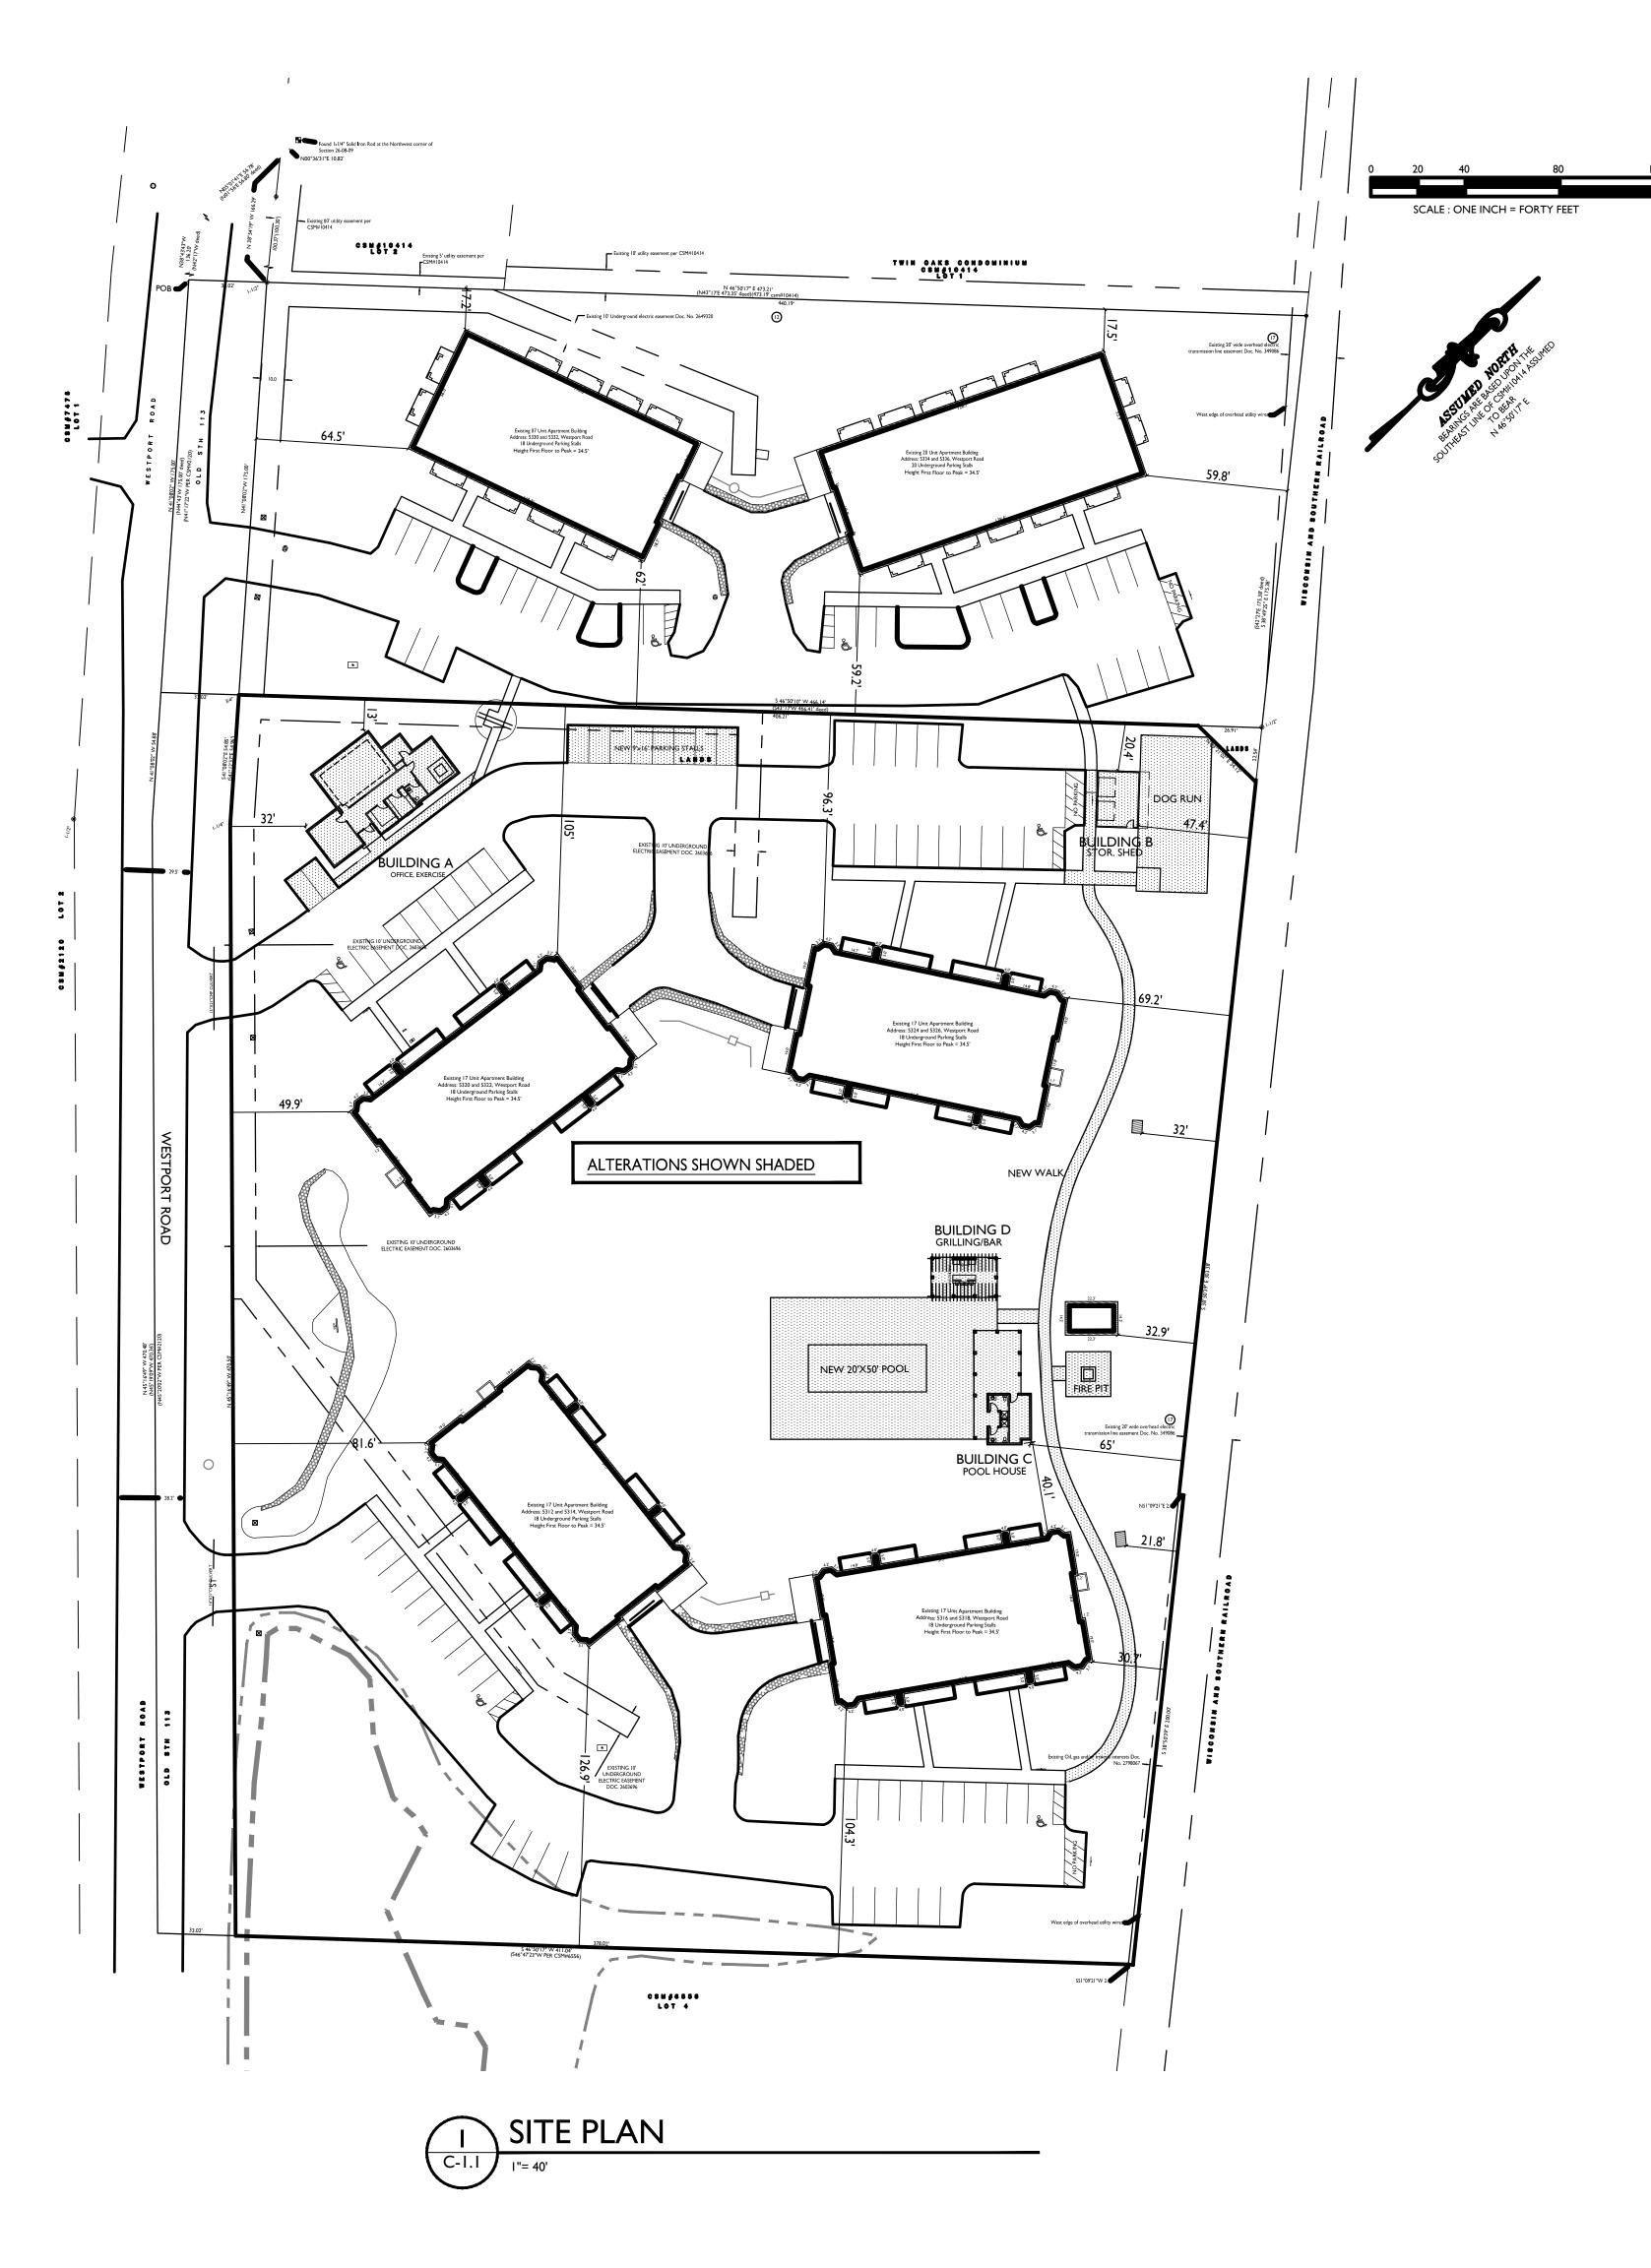

## SHEET INDEX

SITE INFORMATION C-I.I SITE PLAN C-001 CIVIL DETAILS C-100 EXISTING CONDITIONS C-200 SITE PLAN C-300 GRADING PLAN C-400 UTILITY PLAN L-1.0 LANDSCAPE PLAN AT BLDG. A L-1.1 LANDSCAPE PLAN AT POOL L-1.2 LANDSCAPE PLAN AT COURTYARD BUILDING A OFFICE / EXERCISE A-I.Ia FLOOR PLAN A-2.1a ELEVATIONS BUILDING B STORAGE BUILDING A-I.Ib FLOOR PLAN & ELEVATIONS BUILDING C POOL HOUSE A-I.Ic FLOOR PLAN & ELEVATIONS BUILDING D GRILLING / BAR SHELTER A-I.I.d FLOOR PLAN AND ELEVATIONS

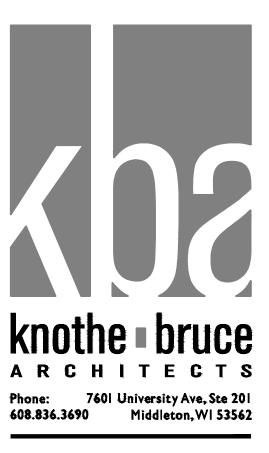


ISSUED Issued To Westport - Jan. 26. 2022

PROJECT TITLE LAKEPOINTE APARTMENTS COMMON SPACE ALTERATIONS

5324 Westport Rd. SHEET TITLE Site Plan

SHEET NUMBER

C-I.I PROJECT NO. 2147 © Knothe & Bruce Architects, LLC

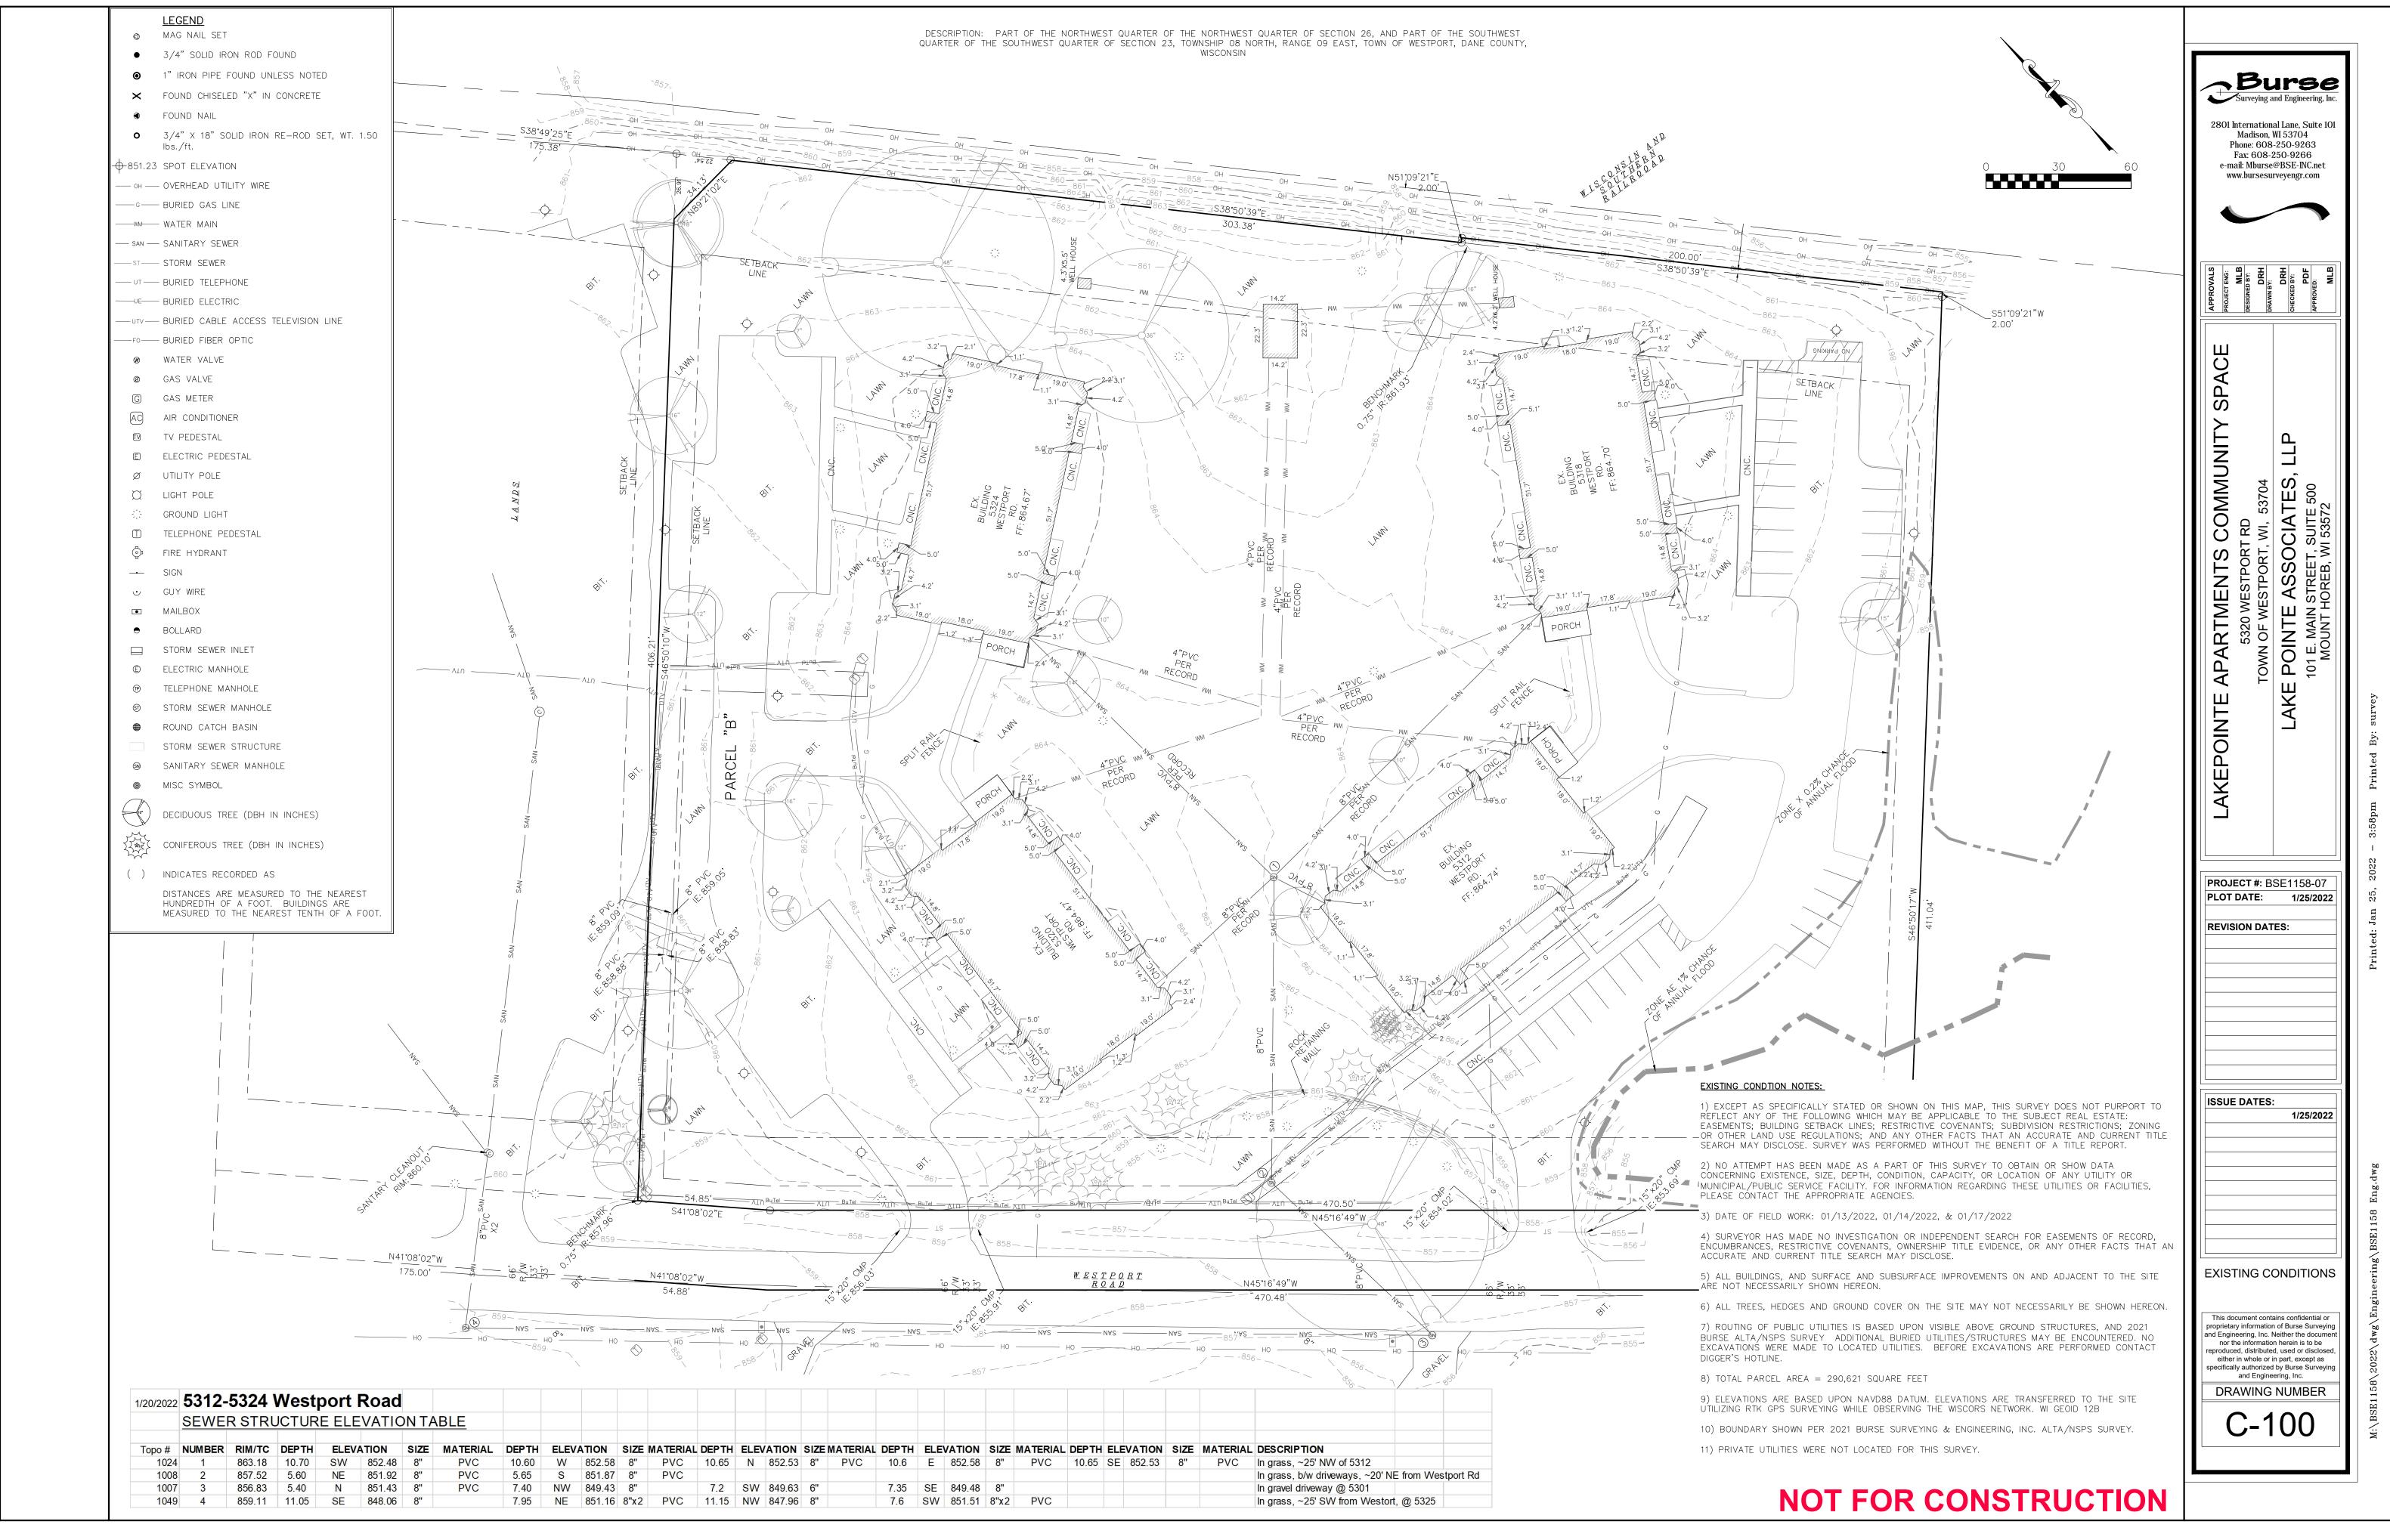

<u>EROSION CONTROL NOTES/SPECIFICATIONS:</u> 1. EROSION CONTROL DEVICES AND/OR STRUCTURES SHALL BE INSTALLED PRIOR TO CLEARING AND GRUBBING OPERATIONS. THESE SHALL BE PROPERLY MAINTAINED FOR MAXIMUM EFFECTIVENESS UNTIL VEGETATION IS
RE-ESTABLISHED. 2. EROSION CONTROL IS THE RESPONSIBILITY OF THE CONTRACTOR UNTIL ACCEPTANCE OF THIS PROJECT. EROSION CONTROL MEASURES AS SHOWN SHALL BE THE MINIMUM PRECAUTIONS THAT WILL BE ALLOWED. THE CONTRACTOR SHALL BE RESPONSIBLE FOR RECOGNIZING AND CORRECTING ALL EROSION CONTROL
<ul> <li>PROBLEMS THAT ARE THE RESULT OF CONSTRUCTION ACTIVITIES. ADDITIONAL EROSION CONTROL MEASURES, AS REQUESTED IN WRITING BY THE STATE OR LOCAL INSPECTORS, OR THE DEVELOPER'S ENGINEER, SHALL BE INSTALLED WITHIN 24 HOURS.</li> <li>3. ALL EROSION CONTROL MEASURES AND STRUCTURES SERVING THE SITE MUST BE INSPECTED AT LEAST WEEKLY OR WITHIN 24 HOURS OF THE TIME 0.5 INCHES OF RAIN IS PRODUCED. ALL MAINTENANCE WILL</li> </ul>
FOLLOW AN INSPECTION WITHIN 24 HOURS. INSPECTION SCHEDULE AND RECORD KEEPING SHALL COMPLY WITH NR 216.46(9), WIS. ADM. CODE.
4. CONSTRUCTION ENTRANCES – PROVIDE A STONE TRACKING PAD AT EACH POINT OF ACCESS. INSTALL ACCORDING TO WDNR STANDARD 1057. REFER TO WDNR'S STORMWATER WEB PAGE OF TECHNICAL STANDARDS AT: HTTP://DNR.WI.GOV/TOPIC/STORMWATER/STANDARDS/CONST_STANDARDS.HTML. THE TRACKING PAD MUST BE MAINTAINED IN A CONDITION THAT PREVENTS THE TRACKING OF MATERIAL ONTO THE PUBLIC STREET.
5. SOIL STOCKPILES — A ROW OF SILT FENCE PLACED DOWNSLOPE AND AT LEAST 10 FEET AWAY FROM THE STOCKPILE SHALL PROTECT ALL STOCKPILES. SOIL STOCKPILES THAT ARE INACTIVE FOR MORE THAN 7 CONSECUTIVE DAYS SHALL BE STABILIZED WITH SEED & MULCH, EROSION MAT, POLYMER, OR COVERED WITH TARPS OR SIMILAR MATERIAL. NO STOCKPILE SHALL BE PLACED WITHIN 20 FEET OF A DRAINAGE WAY.
6. DEWATERING — WATER PUMPED FROM THE SITE SHALL BE TREATED BY USING A TEMPORARY SEDIMENTATION BASIN, PORTABLE DEWATERING BASIN, GEOTEXTILE BAG, OR AN EQUIVALENT DEVICE. SHOW ON THE PLAN THE ANTICIPATED LOCATIONS OF DEWATERING ACTIVITY, AND PROVIDE AN ENGINEERING DETAIL OF THE DEWATERING SYSTEM. DEVISES SHALL COMPLY WITH WDNR TECHNICAL STANDARD 1061 FOUND AT: HTTP://DNR.WI.GOV/TOPIC/STORMWATER/STANDARDS/CONST_STANDARDS.HTML THIS WATER SHALL BE DISCHARGED IN A MANNER THAT DOES NOT INDUCE EROSION OF THE SITE OR ADJACENT PROPERTY.
PUMP SIZE (MAX GPM) TYPE I BAG SIZE (SQ-FT) 50 25 100 50 150 75
7. STORM SEWER INLETS – PROVIDE WDOT TYPE D "CATCHALL" INLET PROTECTION OR EQUIVALENT. REFER TO WDOT PRODUCT ACCEPTABILITY LIST AT: HTTP://WWW.DOT.WISCONSIN.GOV/BUSINESS/ENGRSERV/PAL.HTM. INLET PROTECTION SHALL BE INSTALLED PRIOR TO THE STORM SEWER SYSTEM RECEIVING SITE RUNOFF. OTHER THAN FOR PERFORMING MAINTENANCE, THESE DEVICES SHALL NOT BE REMOVED UNTIL PLAT-LEVEL STABILIZATION IS COMPLETE.
8. BUILDING AND WASTE MATERIALS SHALL BE PREVENTED FROM RUNNING—OFF THE SITE AND ENTERING WATERS OF THE STATE IN CONFORMANCE WITH NR151.12(6M).
9. NO SOLID MATERIAL SHALL BE DISCHARGED OR DEPOSITED INTO WATERS OF THE STATE IN VIOLATION OF CH. 30 OR 31 OF THE WISCONSIN STATE STATUTES OR 33 USC 1344 PERMITS.
10. EROSION CONTROL DEVICES SHALL ADHERE TO THE TECHNICAL STANDARDS FOUND AT: HTTP://DNR.WI.GOV/RUNOFF/STORMWATER/TECHSTDS.HTM AND COMPLY WITH ALL DANE COUNTY ORDINANCES.
11. ALL DEBRIS TRACKED ONTO PUBLIC STREETS SHALL BE BE SWEPT OR SCRAPED CLEAN BY THE END OF EACH WORKDAY.
12. ALL BUILDING AND WASTE MATERIAL SHALL BE HANDLED PROPERLY TO PREVENT RUNOFF OF THESE MATERIALS OFF OF THE SITE.
13. ALL DISTURBED AREAS SHALL BE SEEDED IMMEDIATELY AFTER GRADING FINAL GRADE HAS BEEN ACHIEVED.
14. IMMEDIATELY STABILIZE ALL DISTURBED AREAS THAT WILL REMAIN INACTIVE FOR 14 DAYS OR LONGER. BETWEEN SEPTEMBER 15 AND OCTOBER 15: STABILIZE WITH MULCH, TACKIFIER, AND A PERENNIAL SEED MIXED WITH WINTER WHEAT, ANNUAL OATS, OR ANNUAL RYE. OCTOBER 15 THROUGH COLD WEATHER: STABILIZE WITH A POLYMER AND DORMANT SEED MIX.
15. ALL DISTURBED AREAS, EXCEPT PAVED AREAS, SHALL RECEIVE A MINIMUM OF FOUR (4) INCHES OF TOPSOIL, FERTILIZER, SEED, AND MULCH. SEED MIXTURES SHALL BE SELECTED APPROPRIATE TO THE INTENDED FUNCTION. A QUALIFIED LANDSCAPING CONTRACTOR, LANDSCAPE ARCHITECT OR NURSERY CAN BE CONSULTED FOR RECOMMENDATIONS. SEEDING RATES SHALL BE BASED ON POUNDS OR OUNCES OF PURE LIVE SEED PER ACRE AND SHALL BE PROVIDED BY THE SEED SUPPLIER. FERTILIZER CAN BE APPLIED TO HELP PROMOTE GROWTH, BUT A SOIL TEST IS RECOMMENDED TO DETERMINE THE TYPE AND AMOUNT OF FERTILIZER TO BE APPLIED. ALL SEEDING AND RESTORATION SHALL BE IN CONFORMANCE TO WDNR TECHNICAL STANDARD 1059 FOUND AT HTTP://DNR.WI.GOV/TOPIC/STORMWATER/STANDARDS/CONST_STANDARDS.HTML. SEEDING AND SODDING MAY ONLY BE USED FROM MAY 1ST TO SEPTEMBER 15TH OF ANY YEAR. TEMPORARY SEED SHALL BE USED
AFTER SEPTEMBER 15. IF TEMPORARY SEEDING IS USED, A PERMANENT COVER SHALL ALSO BE REQUIRED AS PART OF THE FINAL SITE STABILIZATION. 16. FOR THE FIRST SIX (6) WEEKS AFTER THE INITIAL STABILIZATION OF A DISTURBED AREA, WATERING SHALL
BE PERFORMED WHENEVER MORE THAN SEVEN (7) DAYS OF DRY WEATHER ELAPSE.
EMERGENCY CONTACT CRAIG ENZENROTH LAKE POINTE ASSOCIATES, LLP 101 E. MAIN STREET, SUITE 500 MOUNT HOREB, WI 53572 (608) 237–1300 CENZENROTH@GALLINACOS.COM
<u>SCHEDULE:</u> March 1, 2022 INSTALL SILT FENCE AND CONSTRUCTION ENTRANCE. BEGIN DISTURBANCE OF SITE GROUND COVER.
JUNE 14, 2022 SITE GRADING COMPLETE. BASE COURSE INSTALLED. APPLY SEED AND MULCH TO ALL DISTURBED AREAS.
AUGUST 1, 2022 ASPHALT PAVEMENT INSTALLED
OCTOBER 1, 2022 VEGETATION ESTABLISHED.
Dial (800) 242-8511
www.DiggersHotline.com

## <u>SITE PLAN NOTES:</u>


- 1. TRAFFIC CONTROL SIGNAGE SHALL BE IN ACCORDANCE WITH FEDERAL, STATE, COUNTY, CITY, AND LOCAL CODE, WHICHEVER HAS JURISDICTION.
- 2. PAVEMENT MARKINGS AND SIGNAGE PERTAINING TO ACCESSIBLE PARKING STALLS AND ROUTES SHALL CONFORM TO CURRENT ADA REGULATIONS.

3. ALL PAINT STRIPING SHALL HAVE A 4-INCH WIDTH.


## GRADING PLAN NOTES:


1. ALL GRADES ARE FINISH ELEVATION UNLESS NOTED OTHERWISE.


- UTILITY PLAN NOTES: 1. ANY WORK WITHIN THE ROAD RIGHT OF WAY AND PUBLIC EASEMENTS SHALL BE COMPLIANT WITH THE TOWN OF WESTPORT STANDARD SPECIFICATION THE TIME OF CONSTRUCTION.
- 2. ALL PRIVATE UTILITIES (GAS, ELECTRIC, AND TELECOMMUNICATIONS) SERVING EXISTING BUILDINGS SCHEDULED FOR DEMOLITION TO BE ABANDONED OF CORRESPONDING UTILITY COMPANY.
- 3. IT IS THE CONTRACTOR'S RESPONSIBILITY TO VERIFY THE LOCATION OF UNDERGROUND UTILITIES. UTILITIES WERE LOCATED BY OBSERVED EVIDENCE PROVIDED BY DIGGER'S HOTLINE.
- 4. CONTRACTOR SHALL VERIFY THE SIZE, TYPE, SLOPE, AND INVERTS OF ALL EXISTING STORM AND SANITARY LATERALS CALLED OUT TO BE CONNECTE SHALL SUBMIT THE INFORMATION ON THE PIPES TO THE TOWN INSPECTOR AND PROJECT CIVIL ENGINEER.
- 5. ANY SIDEWALK, CURB, OR OTHER PUBLIC PROPERTY DAMAGED AS PART OF THE CONSTRUCTION OF THE UTILITIES AND BUILDING SHALL BE REPLACE THE TOWN OF WESTPORT STANDARD SPECIFICATIONS.

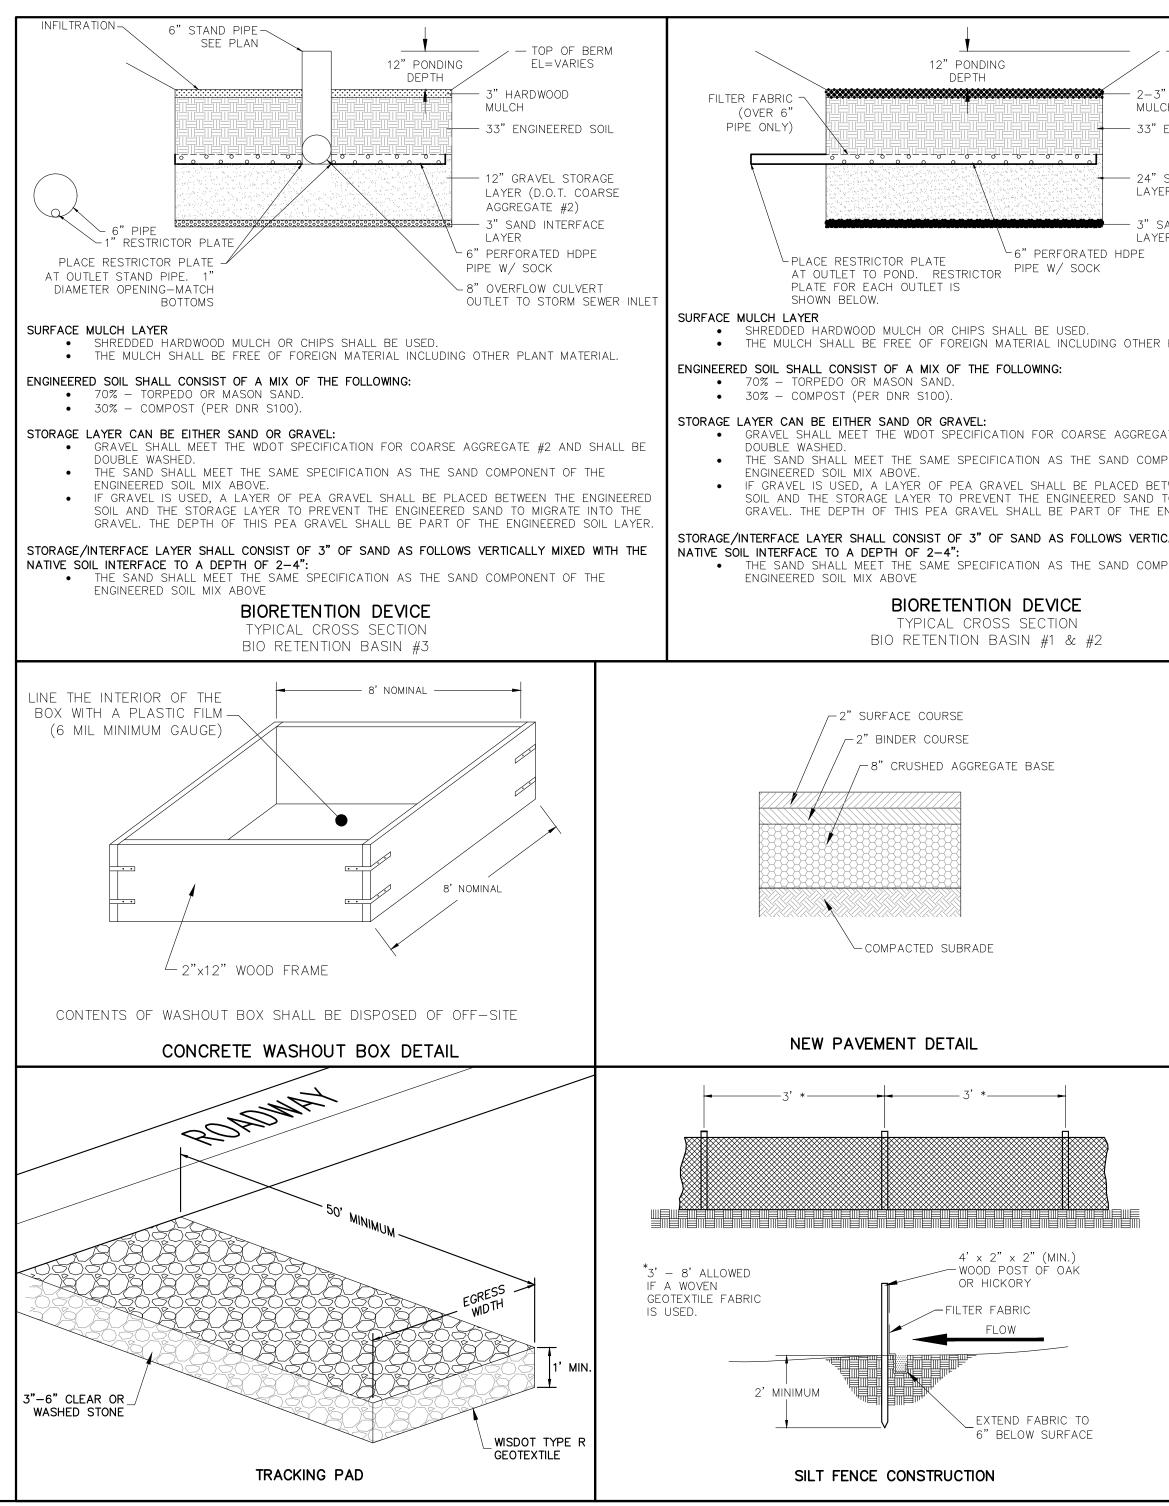



	LEGEND		
	<u> </u>	ACCESSIBLE ROUTE EXISTING EASEMENT	Burse
		PROPERTY BOUNDARY	Surveying and Engineering, Inc.
	#	PARKING STALL COUNT	2801 International Lane, Suite 101
	L.S.	LANDSCAPED AREA	Madison, WI 53704 Phone: 608-250-9263 Fax: 608-250-9266
	BIT. CONC.	BITUMINOUS PAVEMENT CONCRETE PAVEMENT	e-mail: Mburse@BSE-INC.net www.bursesurveyengr.com
	-1041.02	SPOT GRADE	
NS CURRENT AT	¥ FG	FINISH GRADE	
	EG	EXISTING GRADE	
R REMOVED BY	SW	SIDEWALK	
AND MARKINGS	EP	EDGE OF PAVEMENT FLOW LINE	APPROVALS PROJECT ENG: MLB DESIGNED BY: DRH DRAWN BY: CHECKED BY: APPROVED: MLB
	LP	LOW POINT	APP PROJ DRAV CHEC CHEC
ED TO. CONTRACTOR	HP	HIGH POINT	
	ТС	TOP OF CURB	
ED IN-KIND PER	TW BW	TOP OF WALL BOTTOM OF WALL	SPACE
	BOW	BACK OF WALK	S П
- TOP OF BERM EL=VARIES	FOW	FRONT OF WALK	
HARDWOOD	EXP	EXPOSURE	, LLP
CH ENGINEERED SOIL	SAN	PROPOSED SANITARY SEWER	
	st	PROPOSED STORM SEWER PROPOSED WATER LATERAL	53704 TES 72 72
SAND STORAGE	WM	UTILITY LINE DEMOLITION	
	$\times$	TREE REMOVAL	RT R RT R RT, W WI 5.
AND INTERFACE R	·1041·	EXISTING MINOR CONTOUR	
	— — 1040 — —	EXISTING MAJOR CONTOUR	AENT MESTPO ESTPO E ASS HOREB
	1041 1040	PROPOSED MINOR CONTOUR PROPOSED MAJOR CONTOUR	
PLANT MATERIAL.		PROPOSED RIDGE LINE	PARTM 5320 W OWN OF WE POINTE MOUNT H
	· · ·	PROPOSED SWALE/DITCH	
		ACCESSIBLE PARKING SIGN	
TE #2 AND SHALL BE		VISION TRIANGLE (NO VISUAL OBSTRUCTIONS	AKEPOINTE / LAKE
PONENT OF THE		BETWEEN HEIGHTS OF 30" AND 10') RIPRAP	
TWEEN THE ENGINEERED TO MIGRATE INTO THE			
NGINEERED SOIL LAYER.	2026	CONSTRUCTION ENTRANCE	
PONENT OF THE	X	SAW CUT / REMOVAL LIMITS DISTURBANCE LIMITS	
UNENT OF THE		SILT FENCE	
		CHECK DAM	
		DIVERSION BERM	<b>PROJECT #:</b> BSE1158-07
		INLET PROTECTION	PLOT DATE: 1/25/2022
		USLE FLOW PATH	REVISION DATES:
			ISSUE DATES: 1/25/2022
1			
-			
			CIVIL DETAILS
			CIVIL DETAILS
			This document contains confidential or proprietary information of Burse Surveying
		CIVIL SHEET INDEX	This document contains confidential or
		HEET SHEET TITLE	This document contains confidential or proprietary information of Burse Surveying and Engineering, Inc. Neither the document nor the information herein is to be reproduced, distributed, used or disclosed, either in whole or in part, except as specifically authorized by Burse Surveying
	NL		This document contains confidential or proprietary information of Burse Surveying and Engineering, Inc. Neither the document nor the information herein is to be reproduced, distributed, used or disclosed, either in whole or in part, except as
	NL C	HEETSHEET TITLEMBERCIVIL DETAILS-001CIVIL DETAILS-100EXISTING CONDITIONS	This document contains confidential or proprietary information of Burse Surveying and Engineering, Inc. Neither the document nor the information herein is to be reproduced, distributed, used or disclosed, either in whole or in part, except as specifically authorized by Burse Surveying and Engineering, Inc. DRAWING NUMBER
	NU C C	HEET SHEET TITLE MBER CIVIL DETAILS	This document contains confidential or proprietary information of Burse Surveying and Engineering, Inc. Neither the document nor the information herein is to be reproduced, distributed, used or disclosed, either in whole or in part, except as specifically authorized by Burse Surveying and Engineering, Inc.
	NL C C C C C	HEET SHEET TITLE MBER CIVIL DETAILS -001 EXISTING CONDITIONS -200 SITE PLAN	This document contains confidential or proprietary information of Burse Surveying and Engineering, Inc. Neither the document nor the information herein is to be reproduced, distributed, used or disclosed, either in whole or in part, except as specifically authorized by Burse Surveying and Engineering, Inc. DRAWING NUMBER C-OOO1

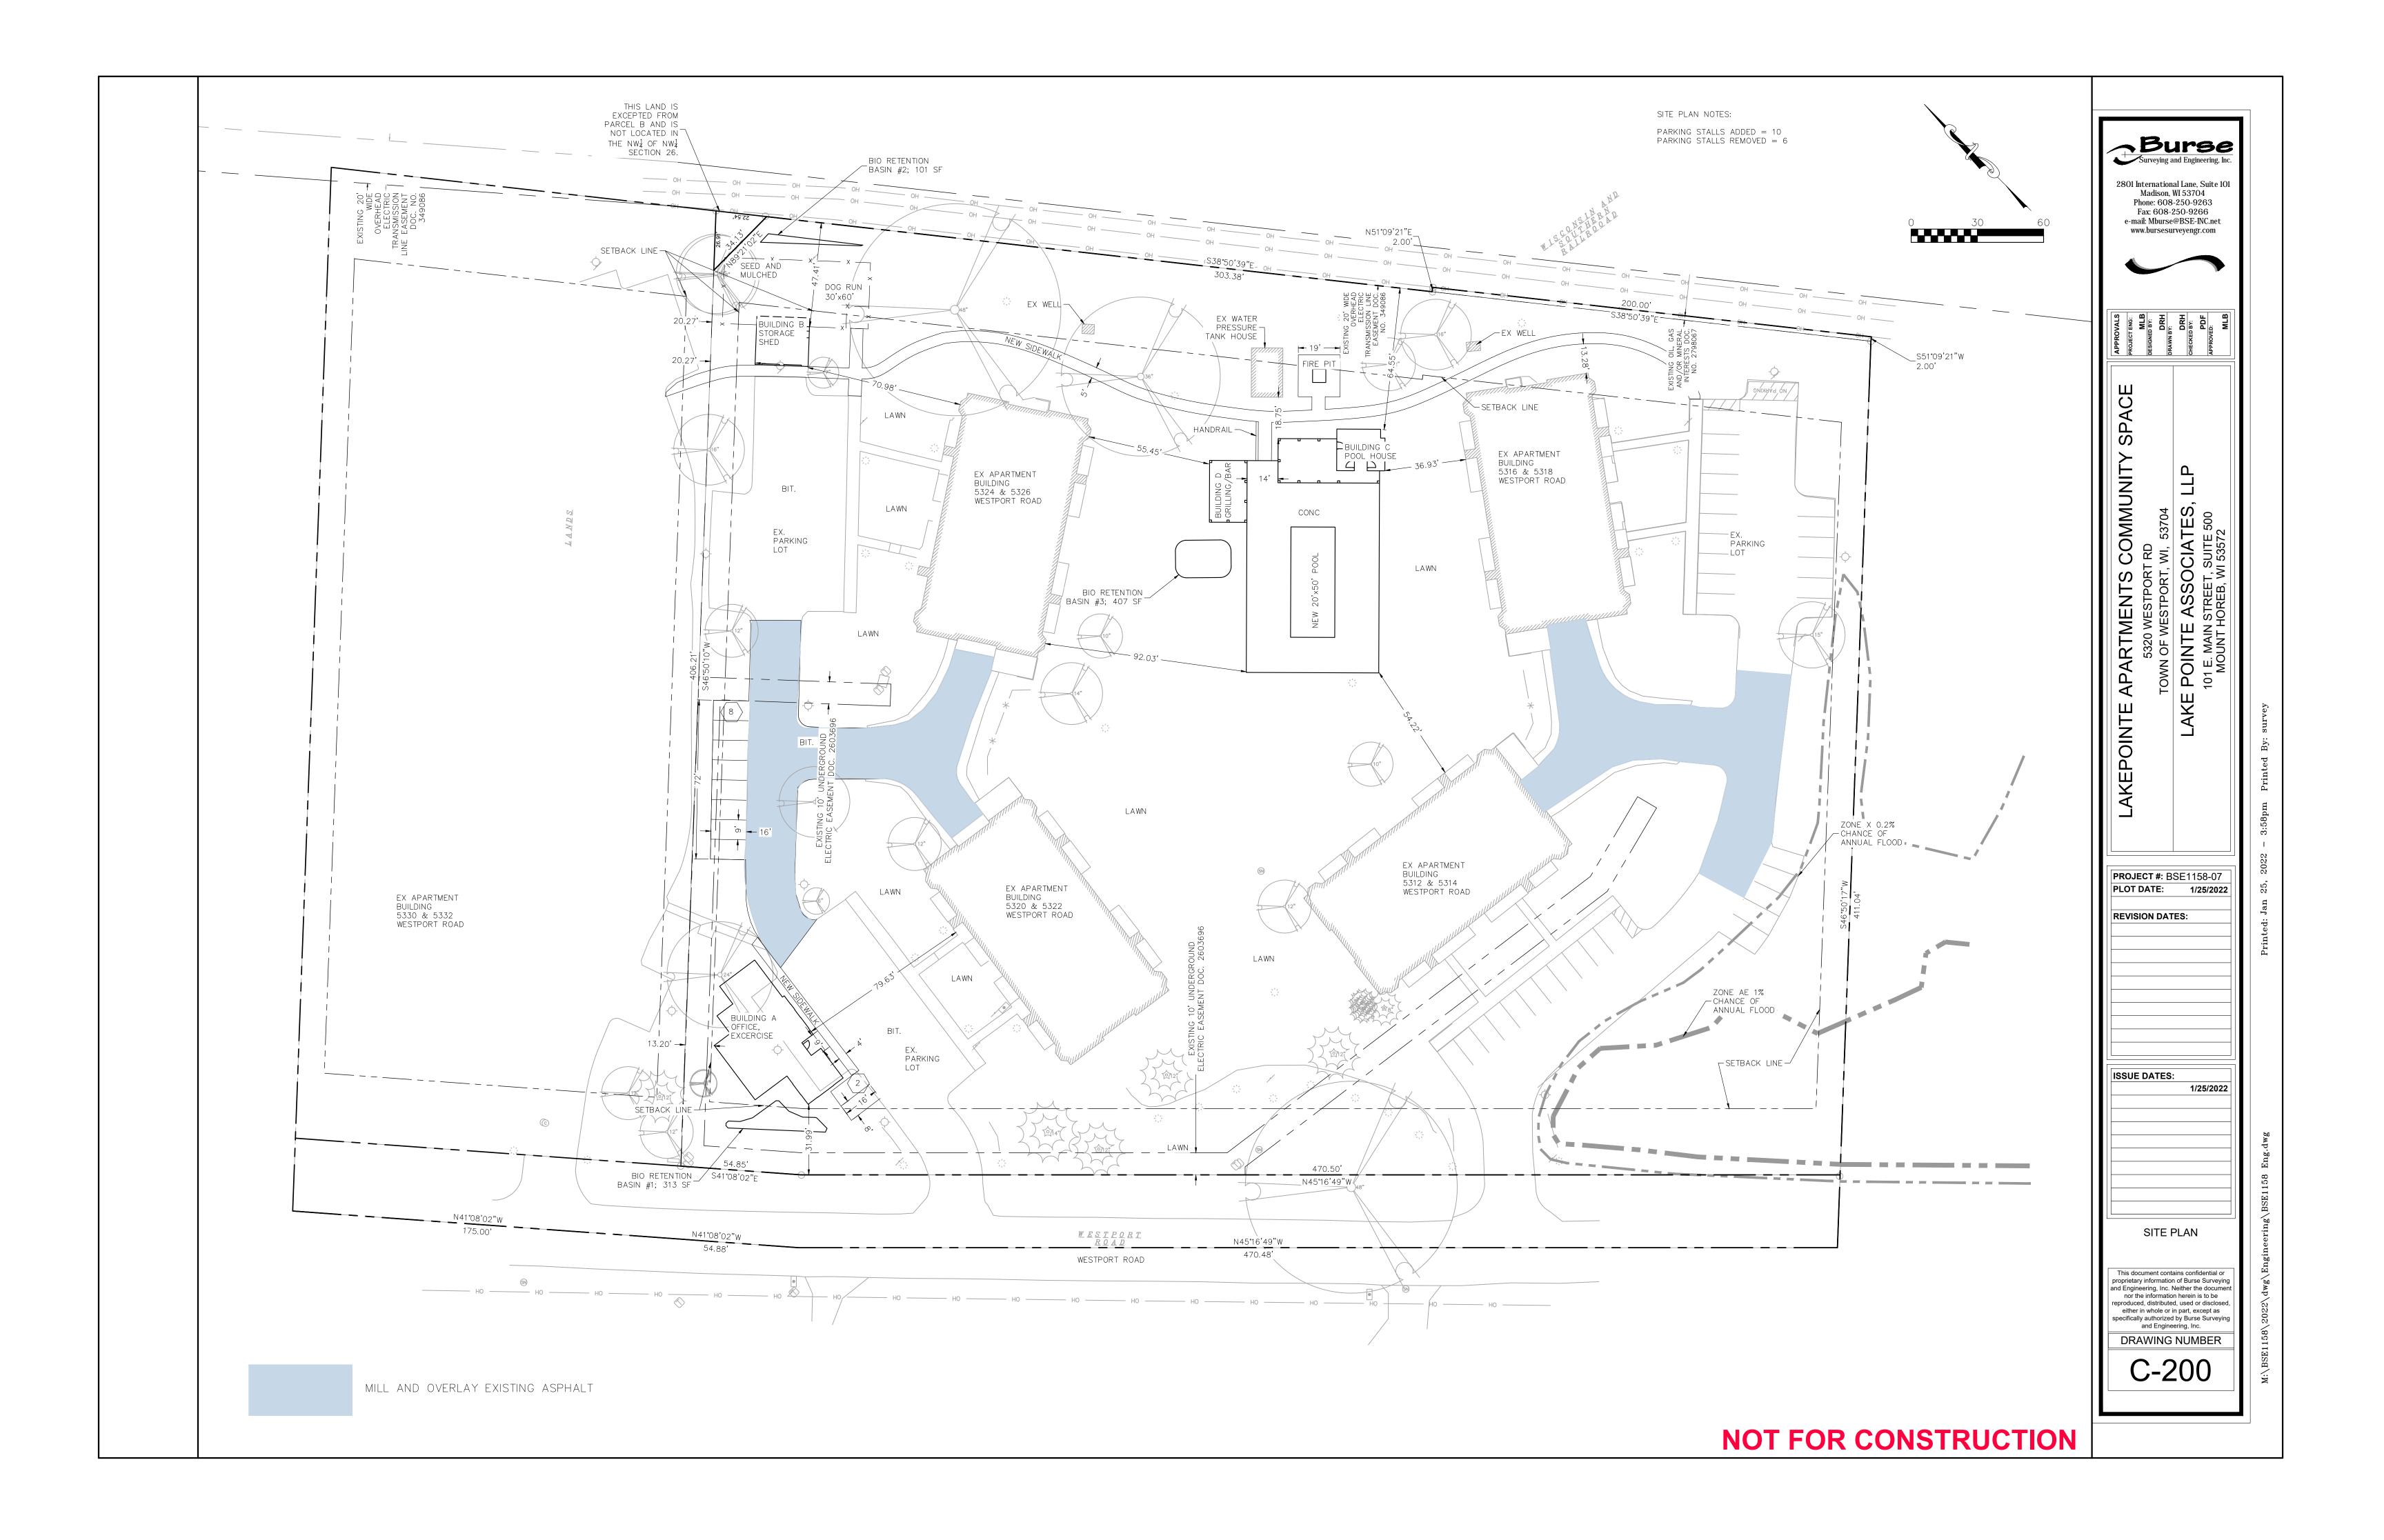


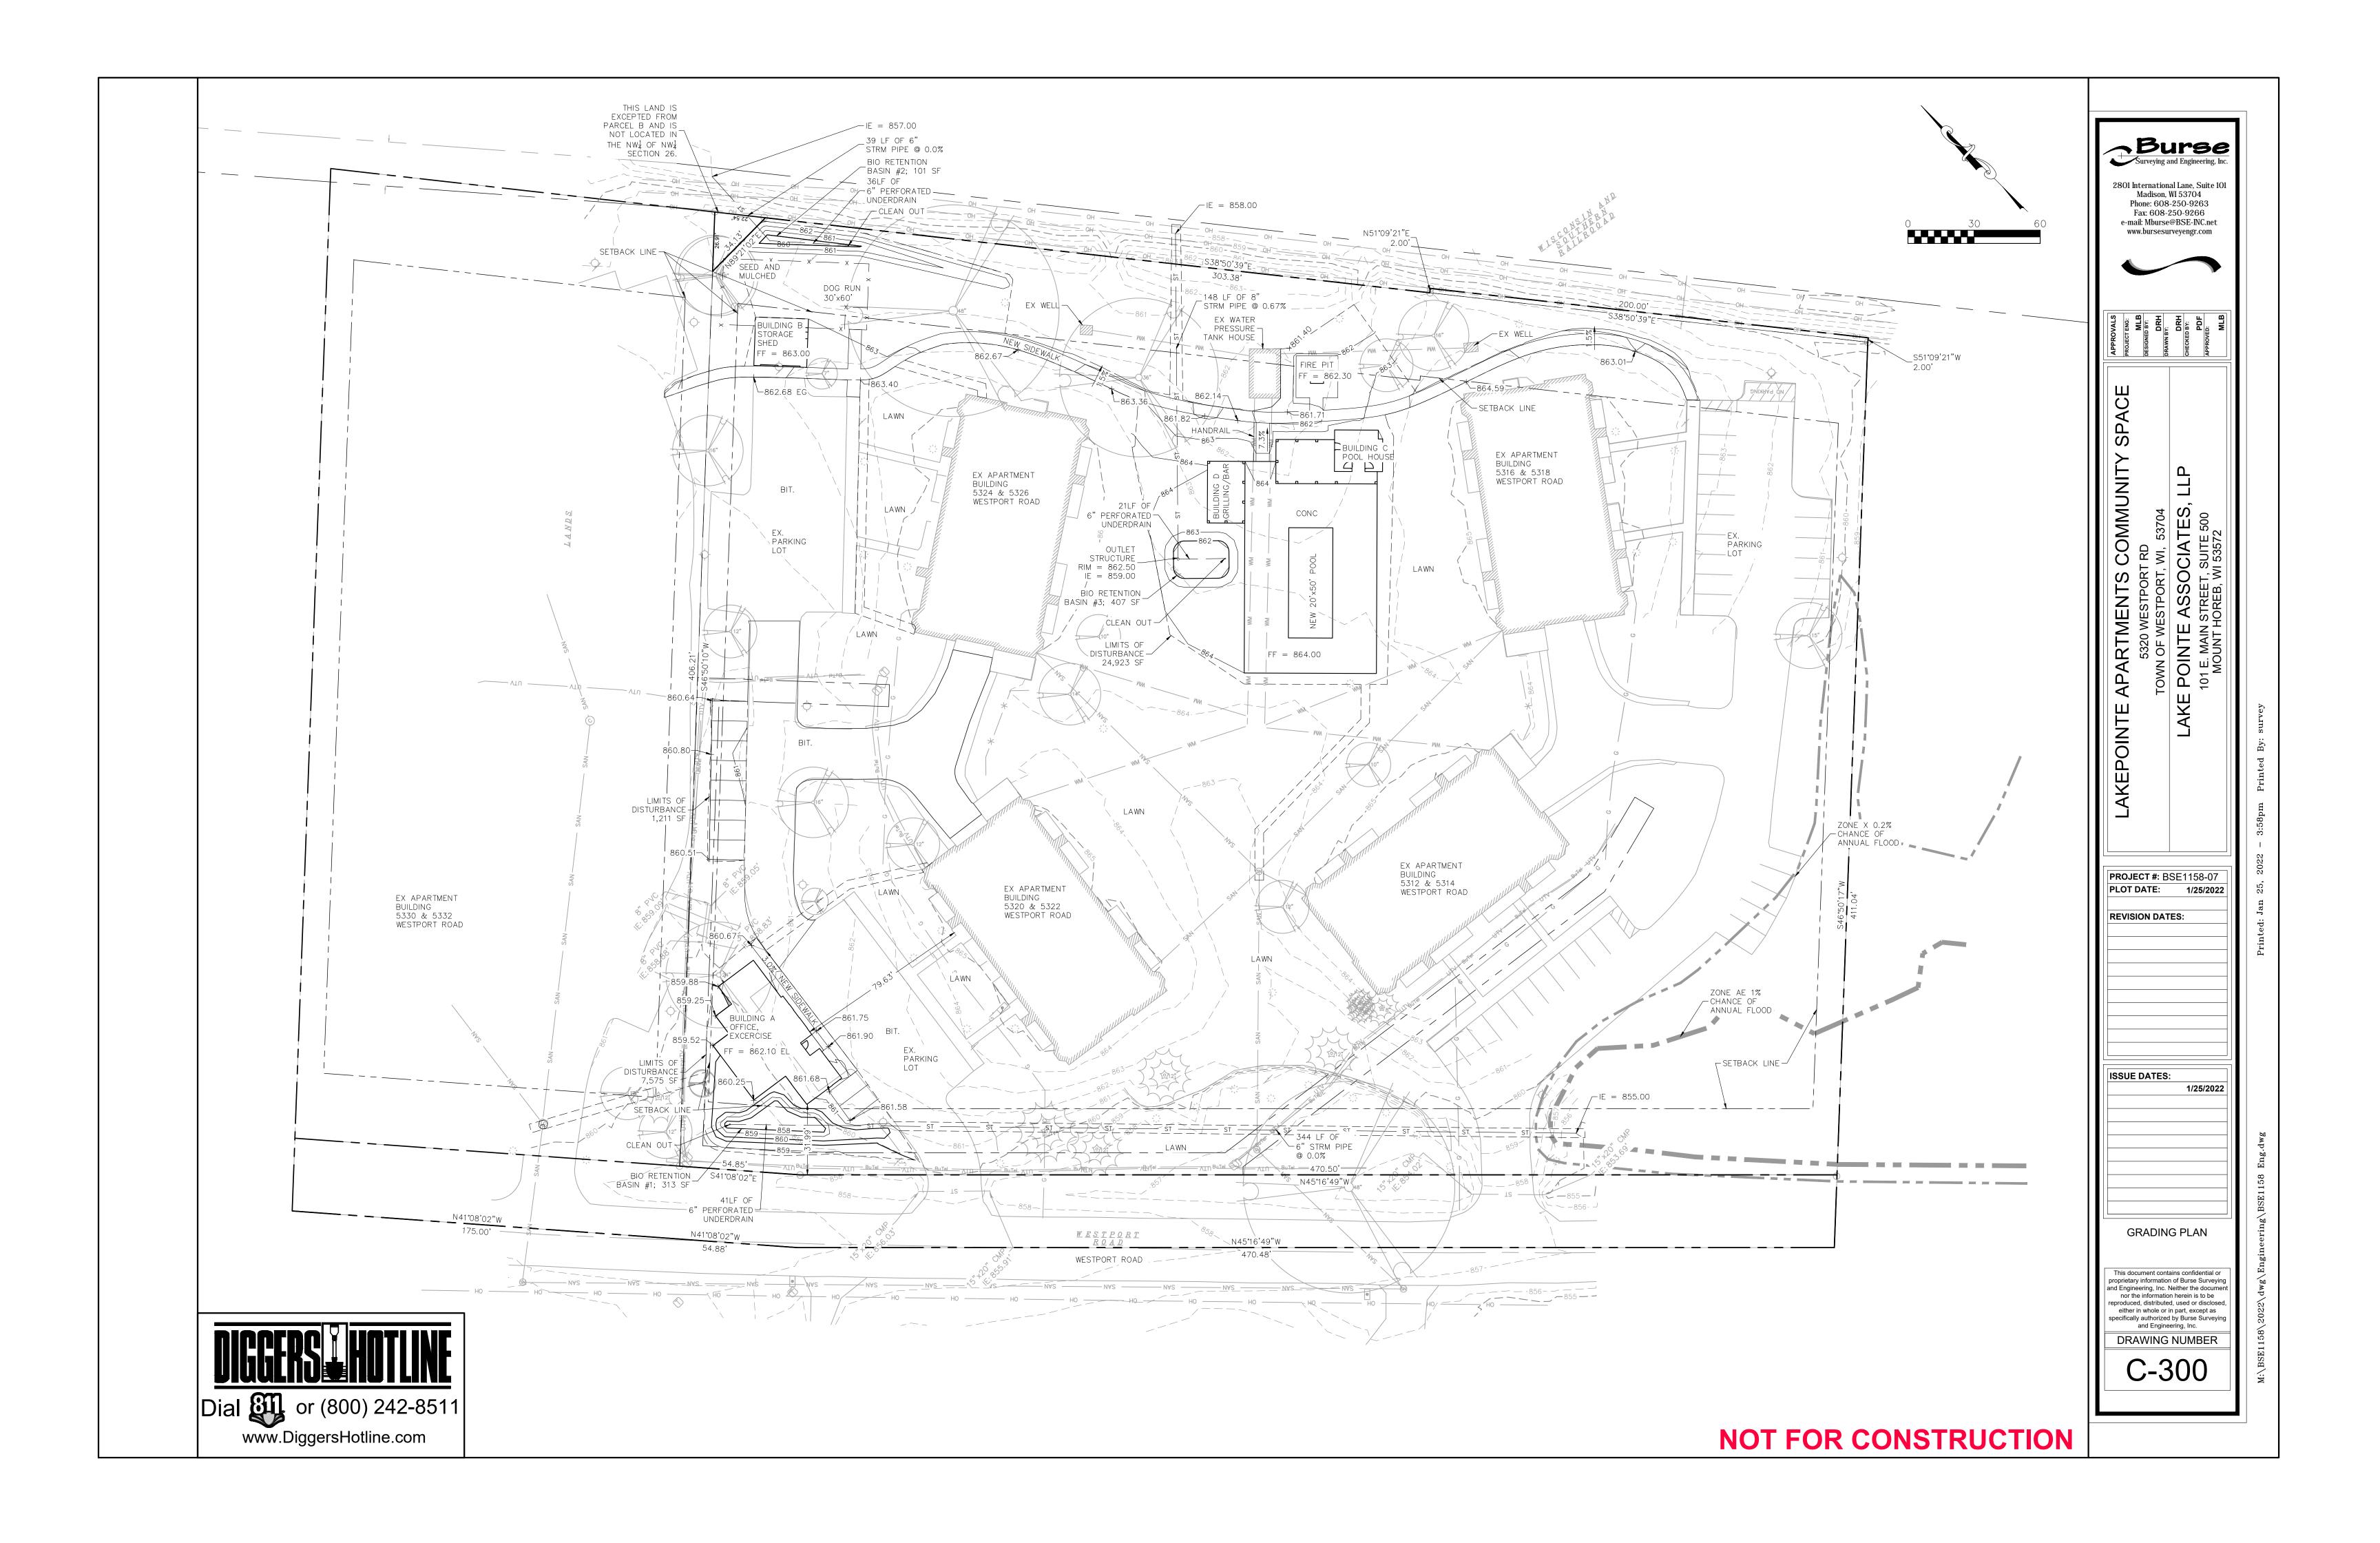


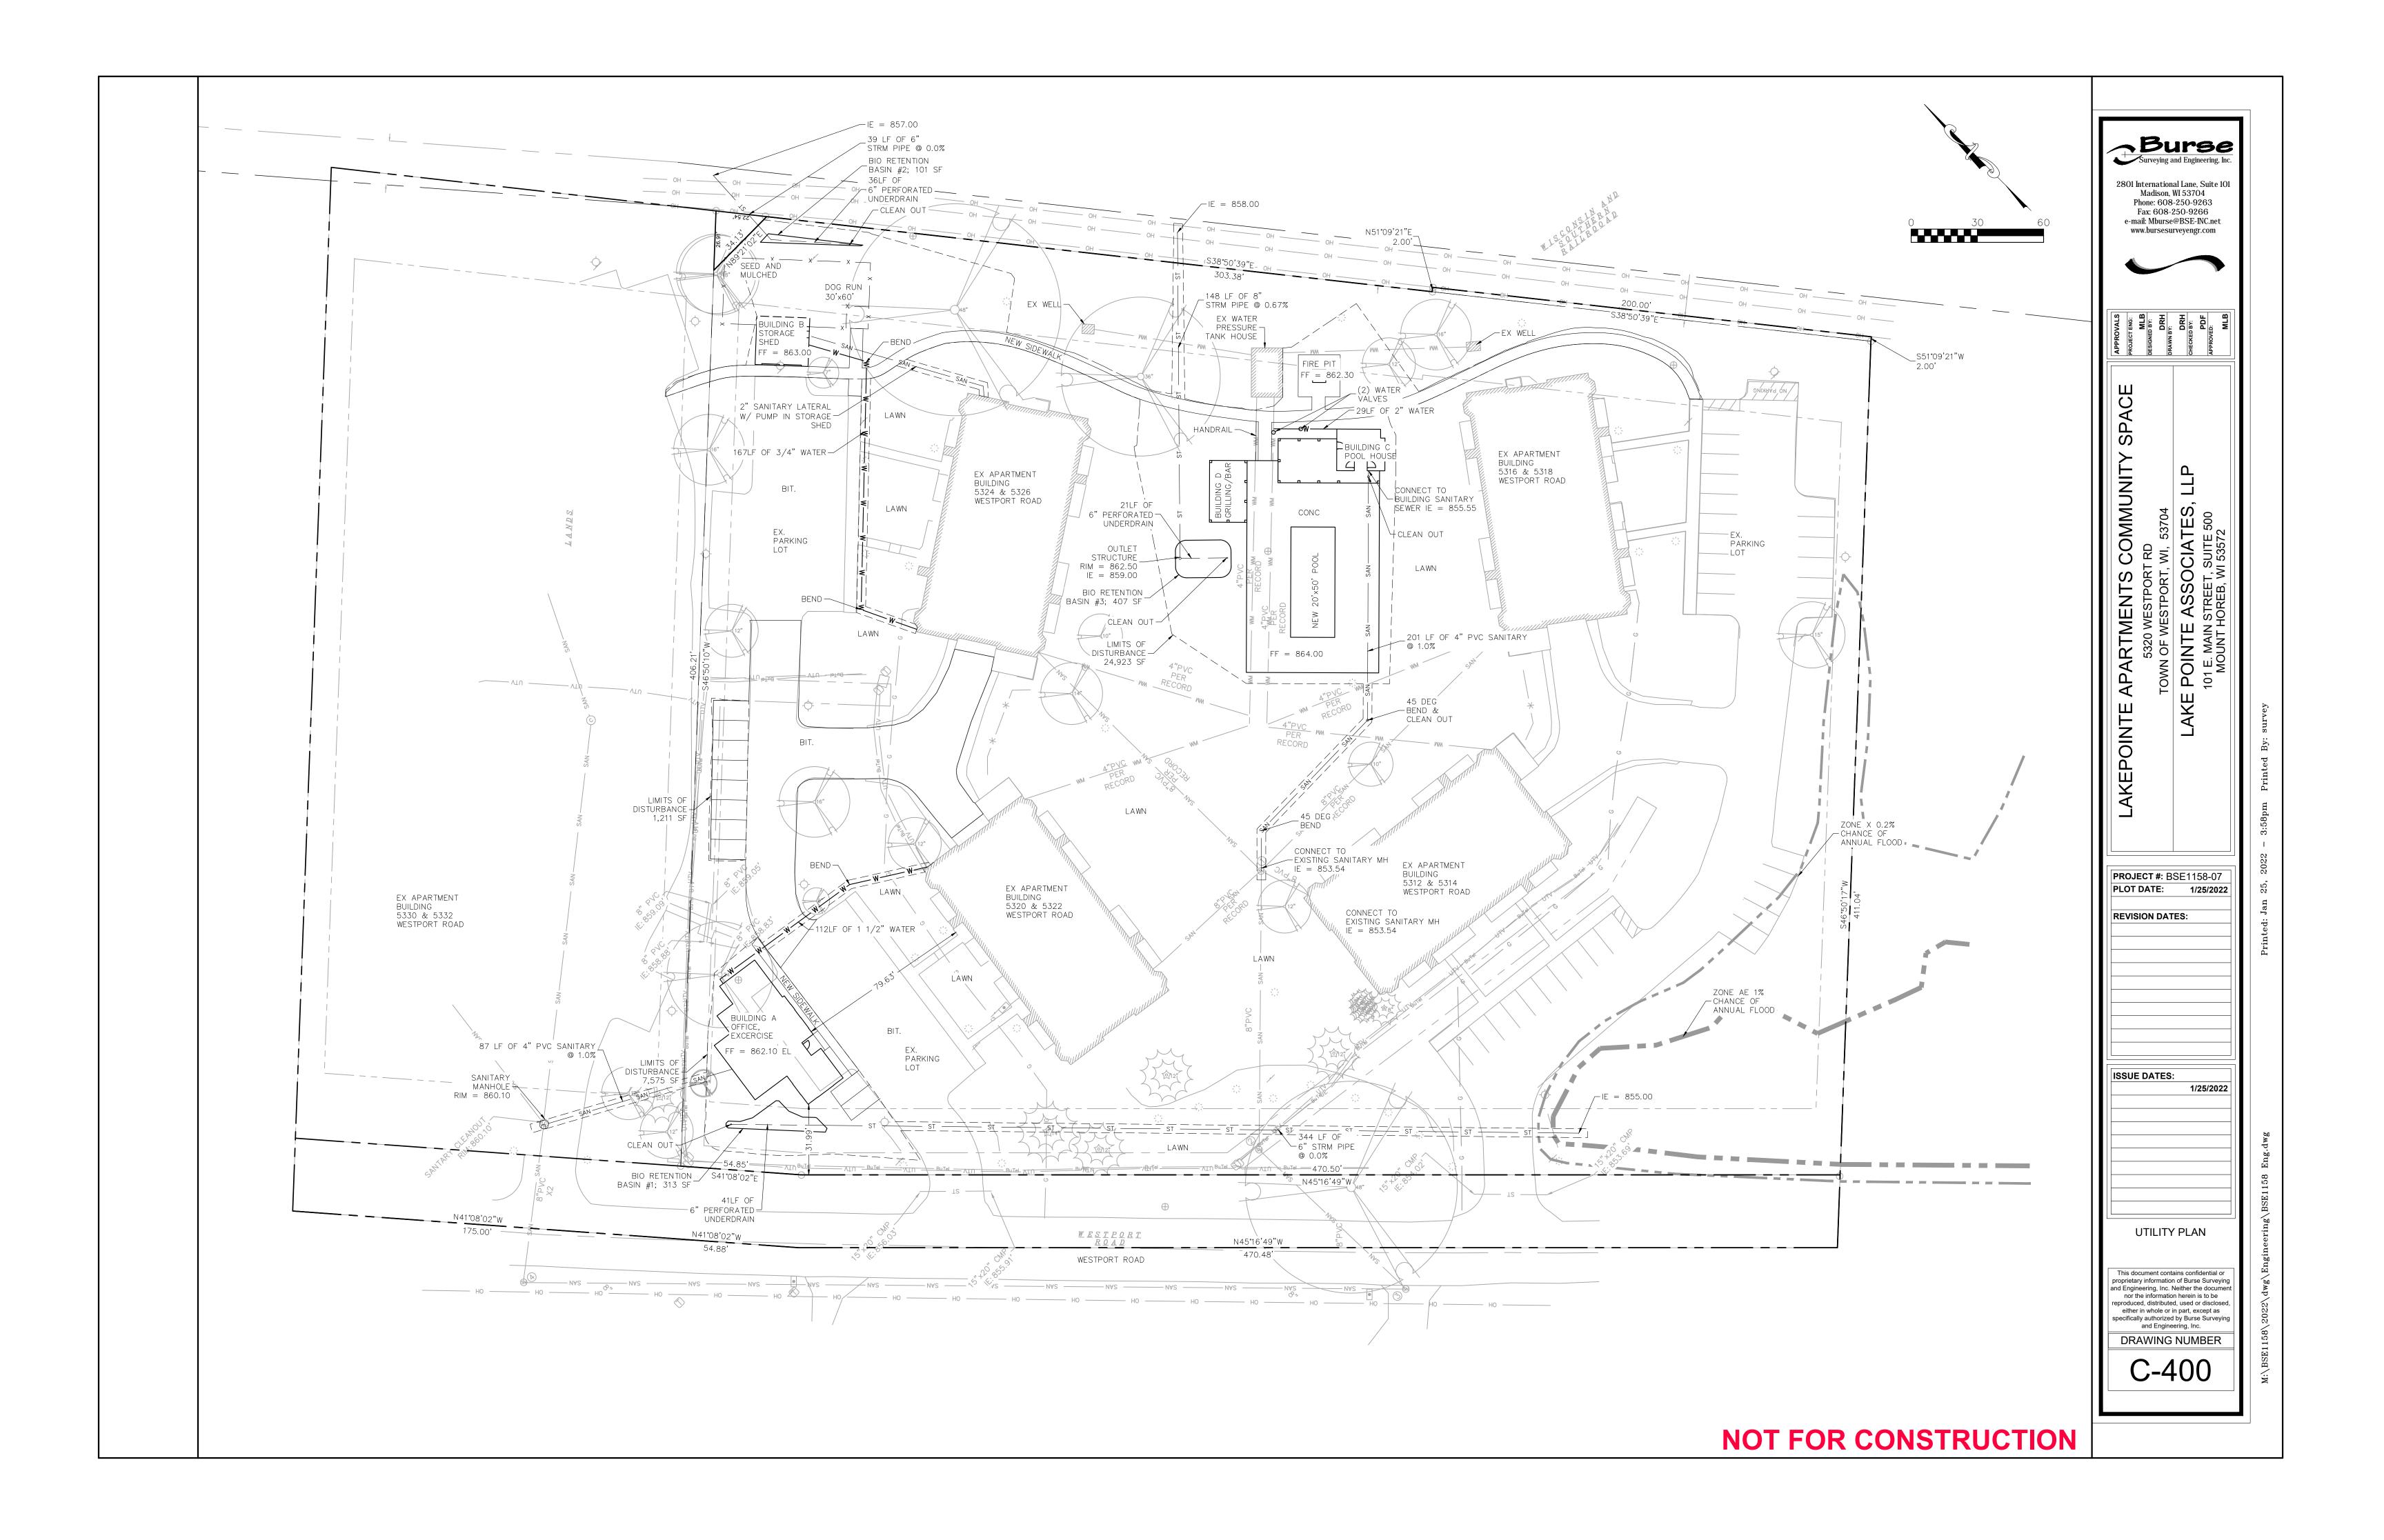

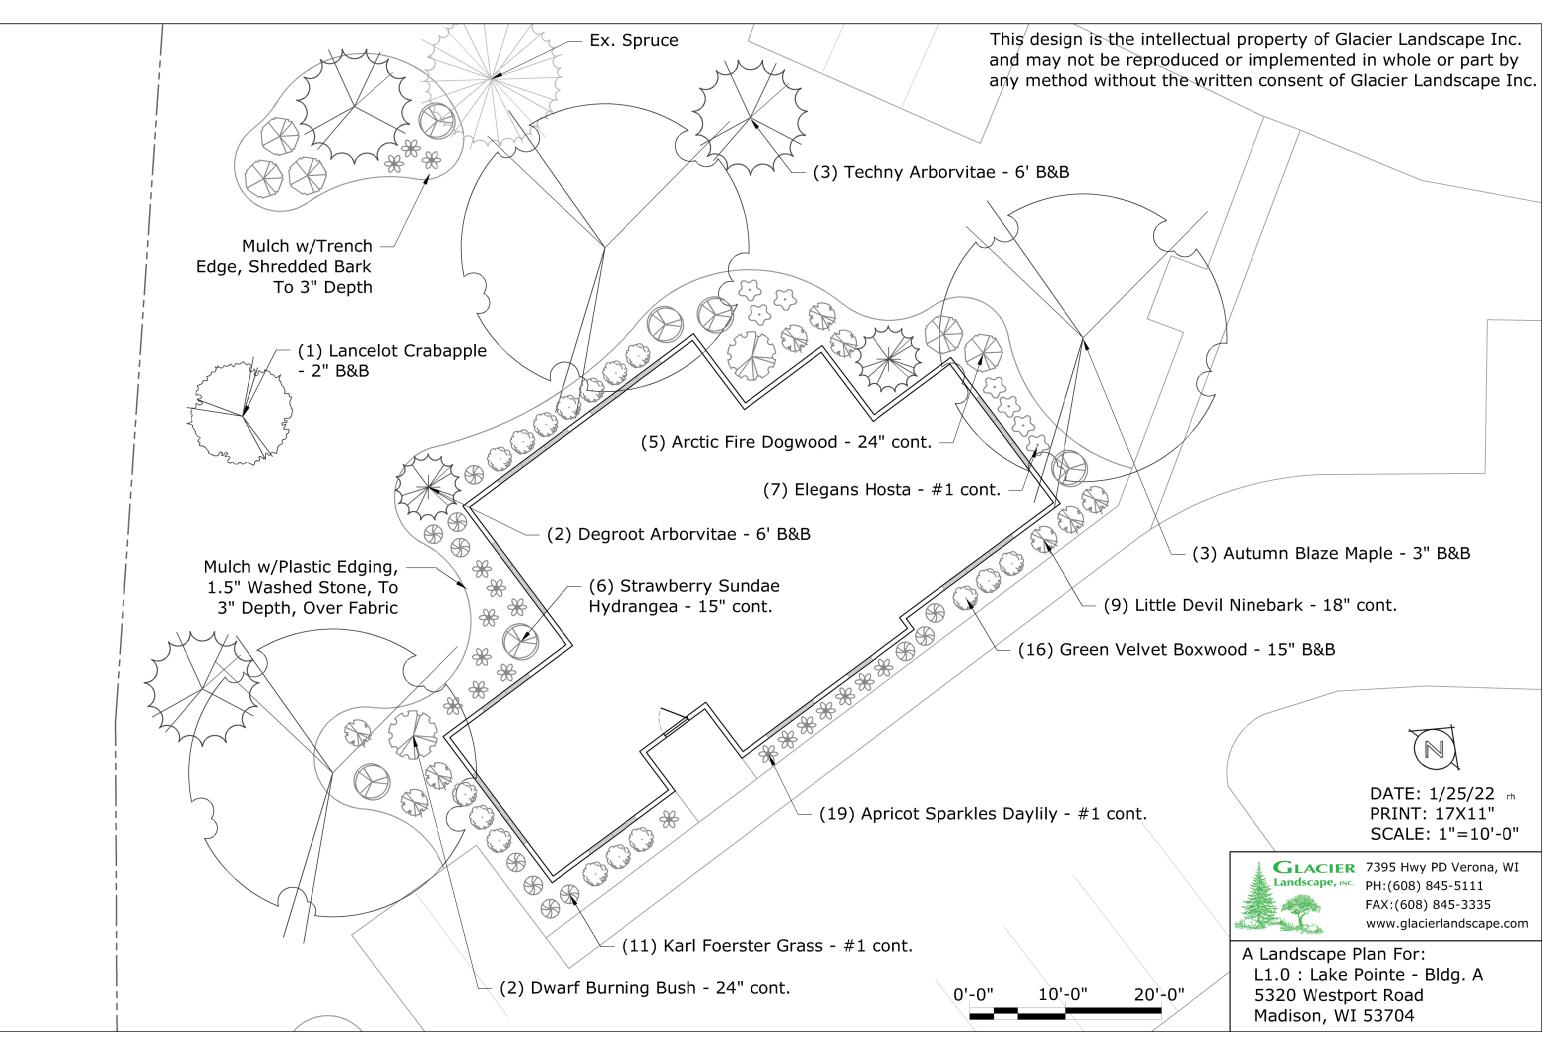

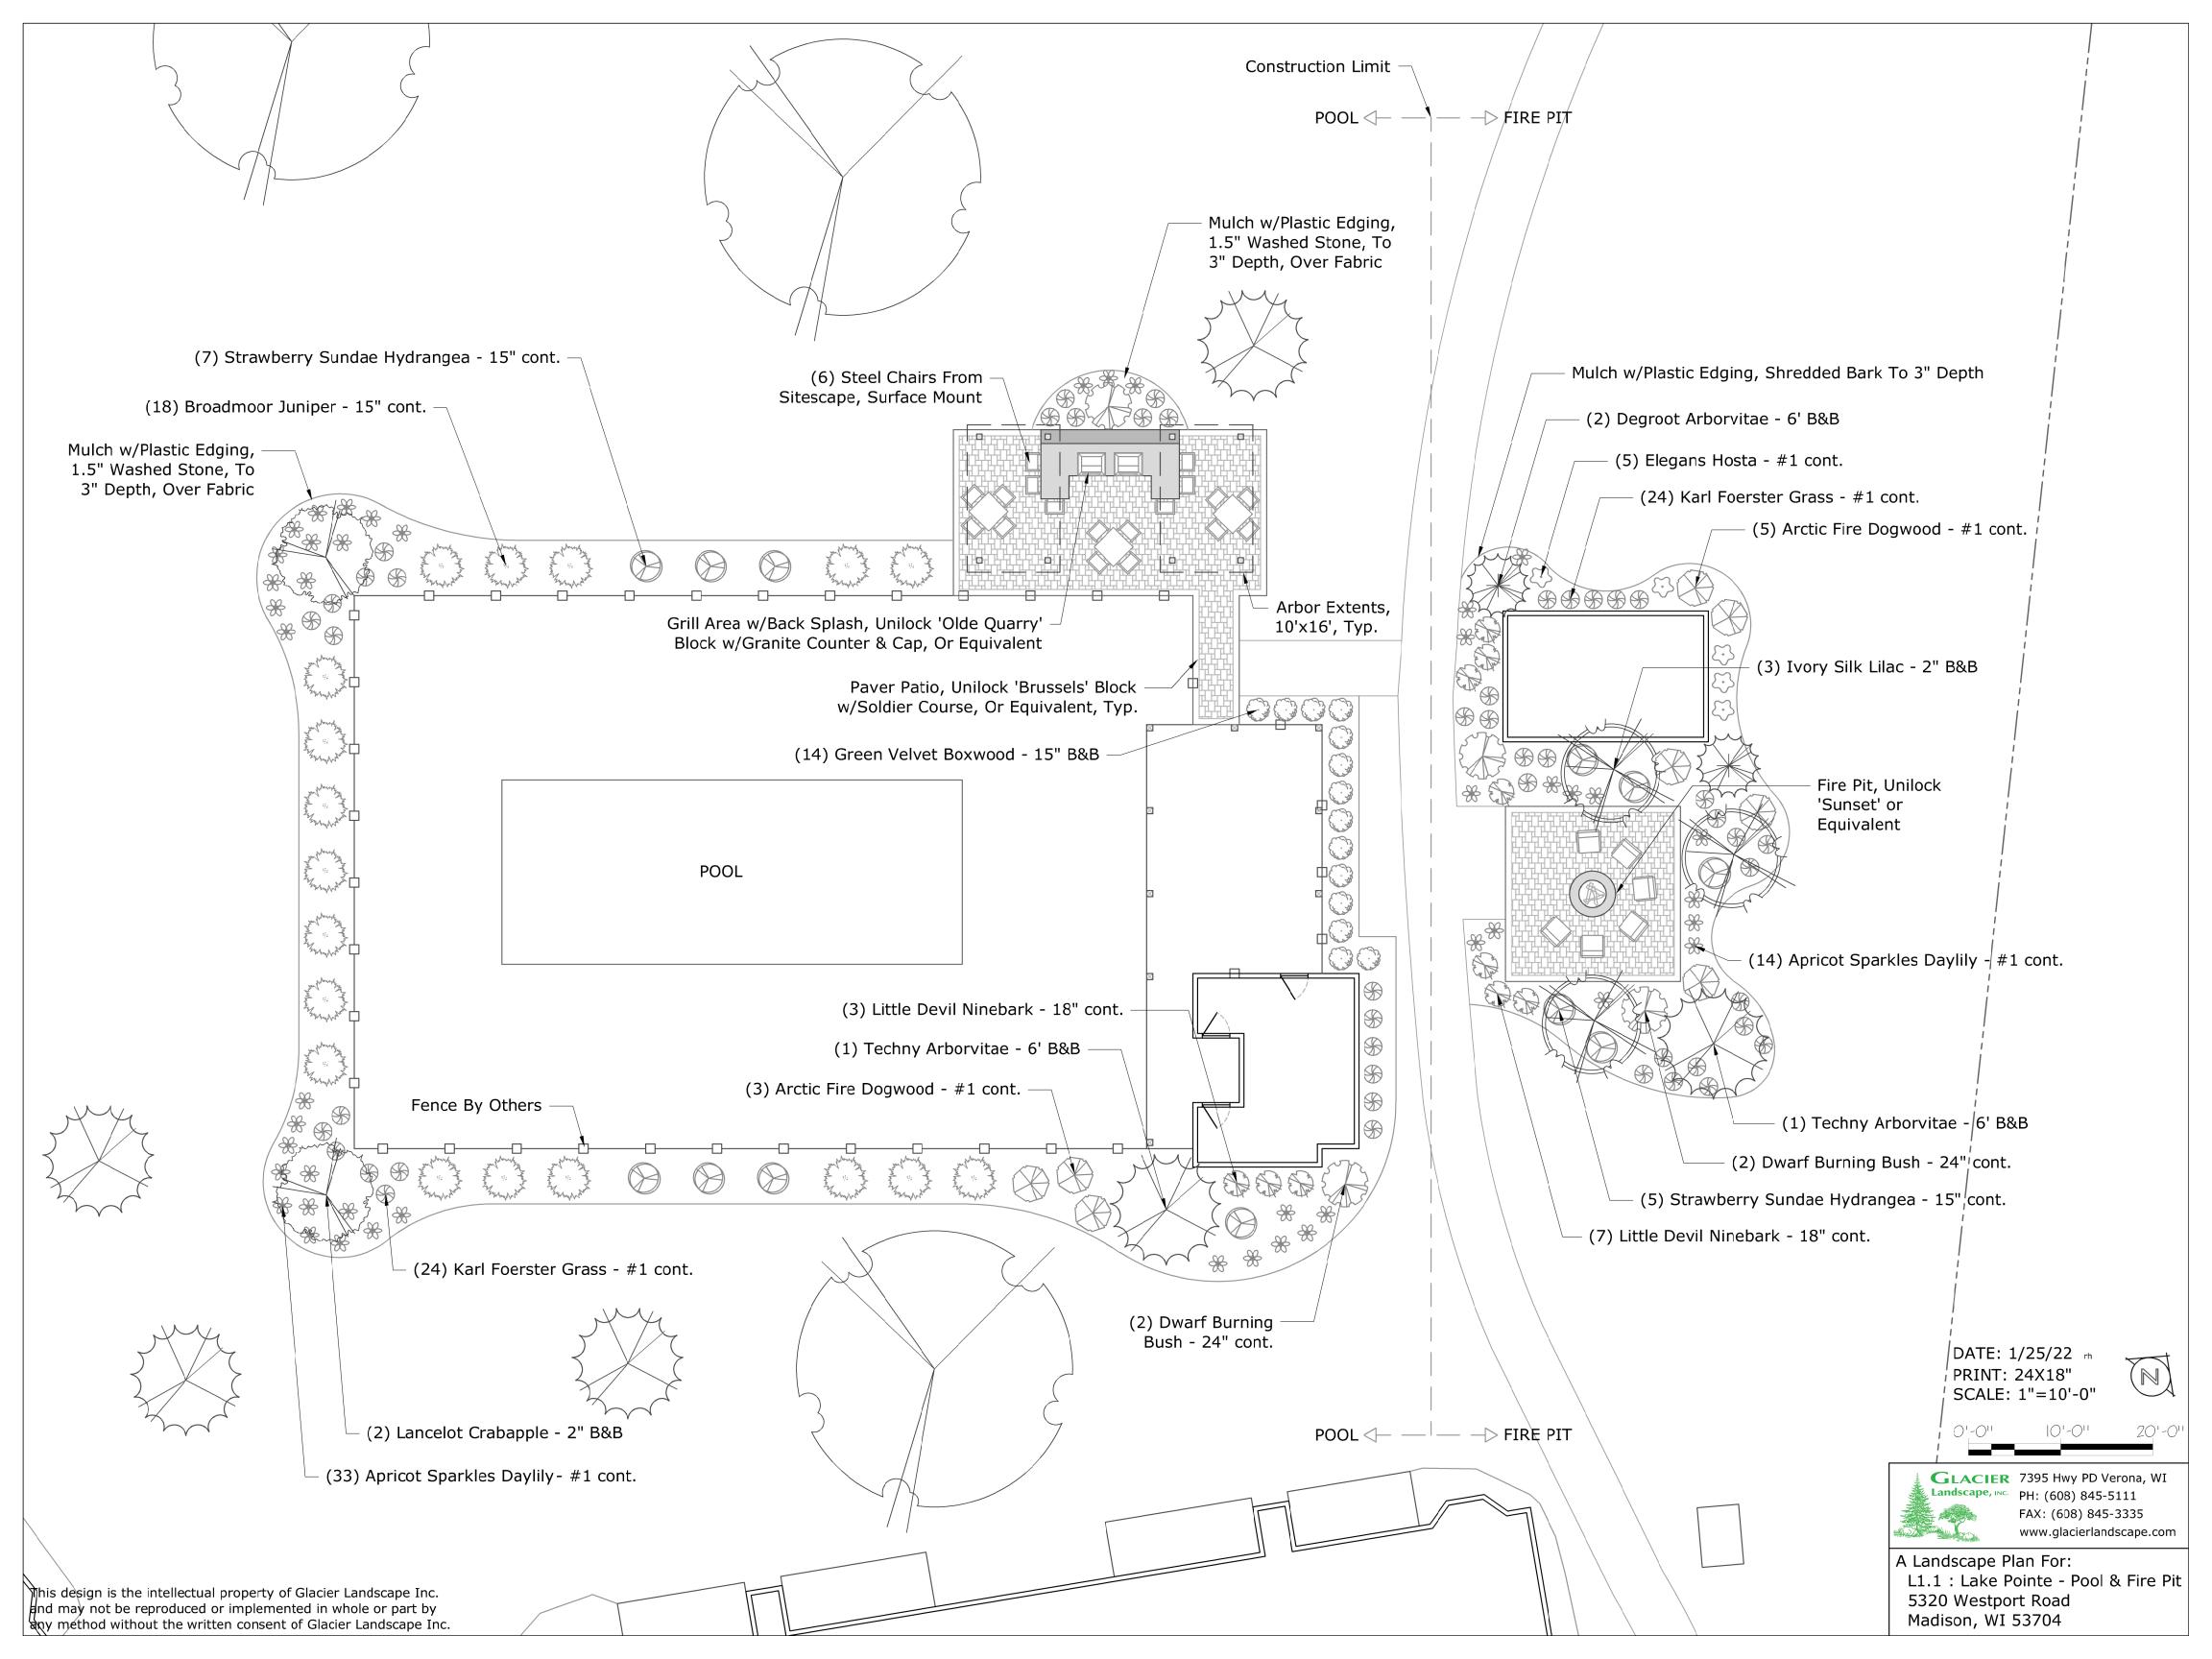


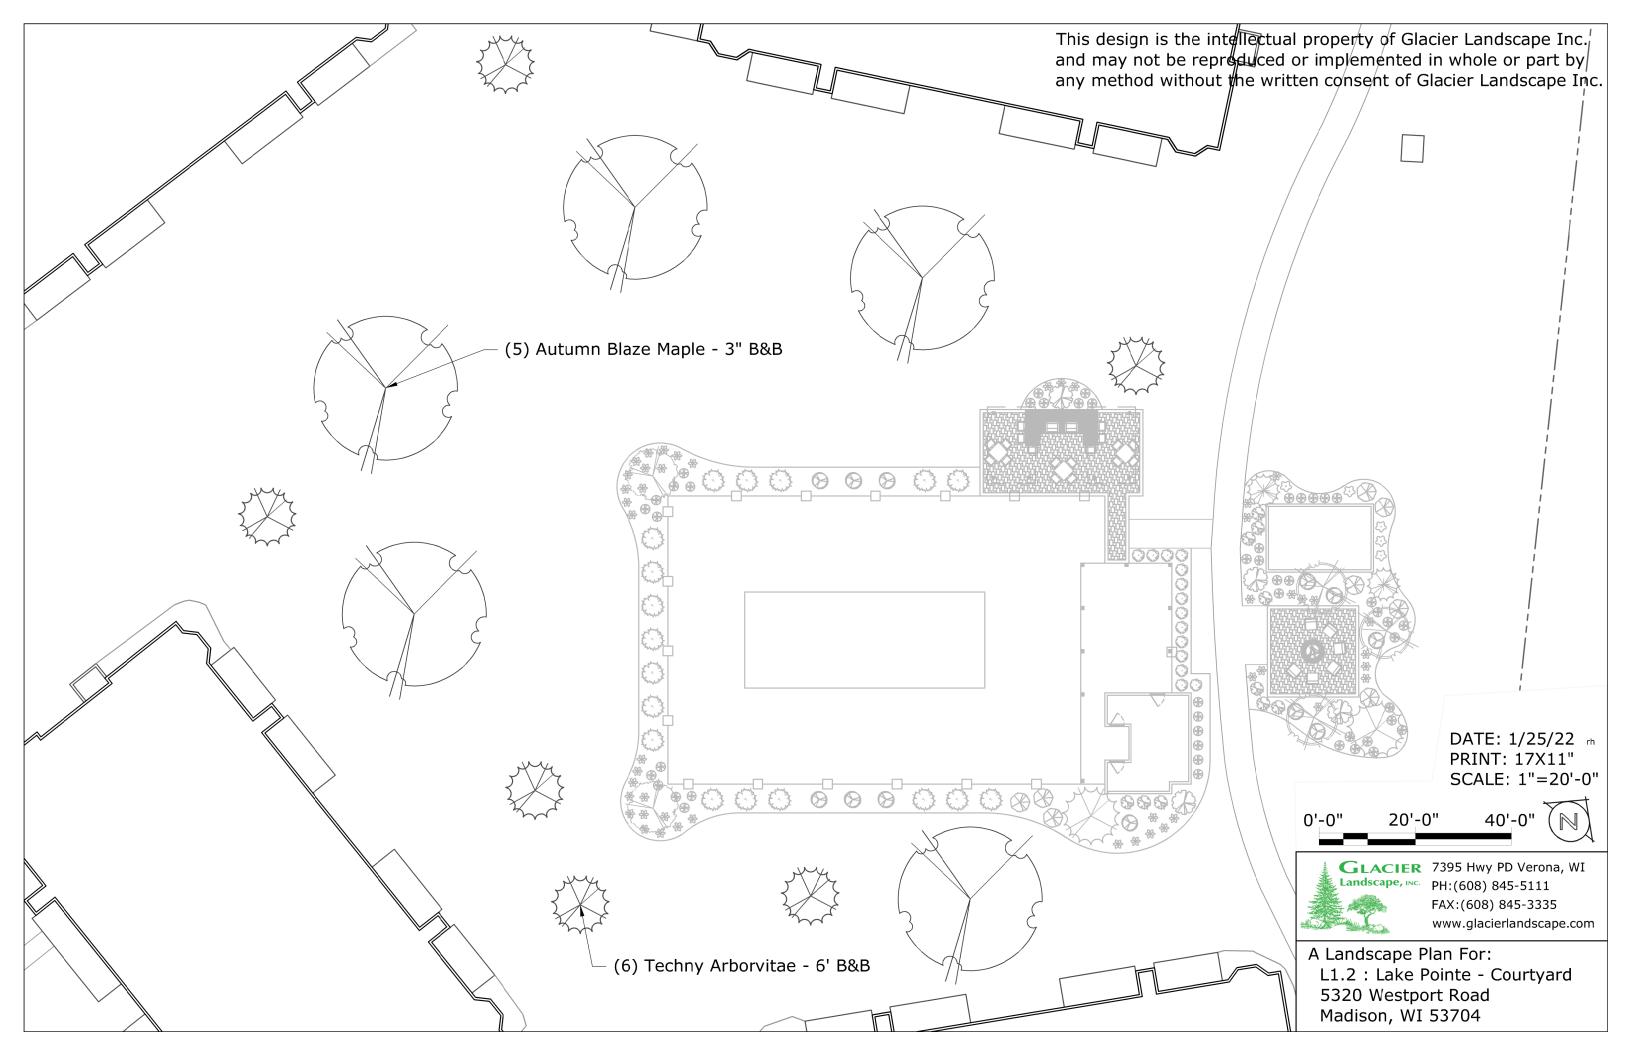

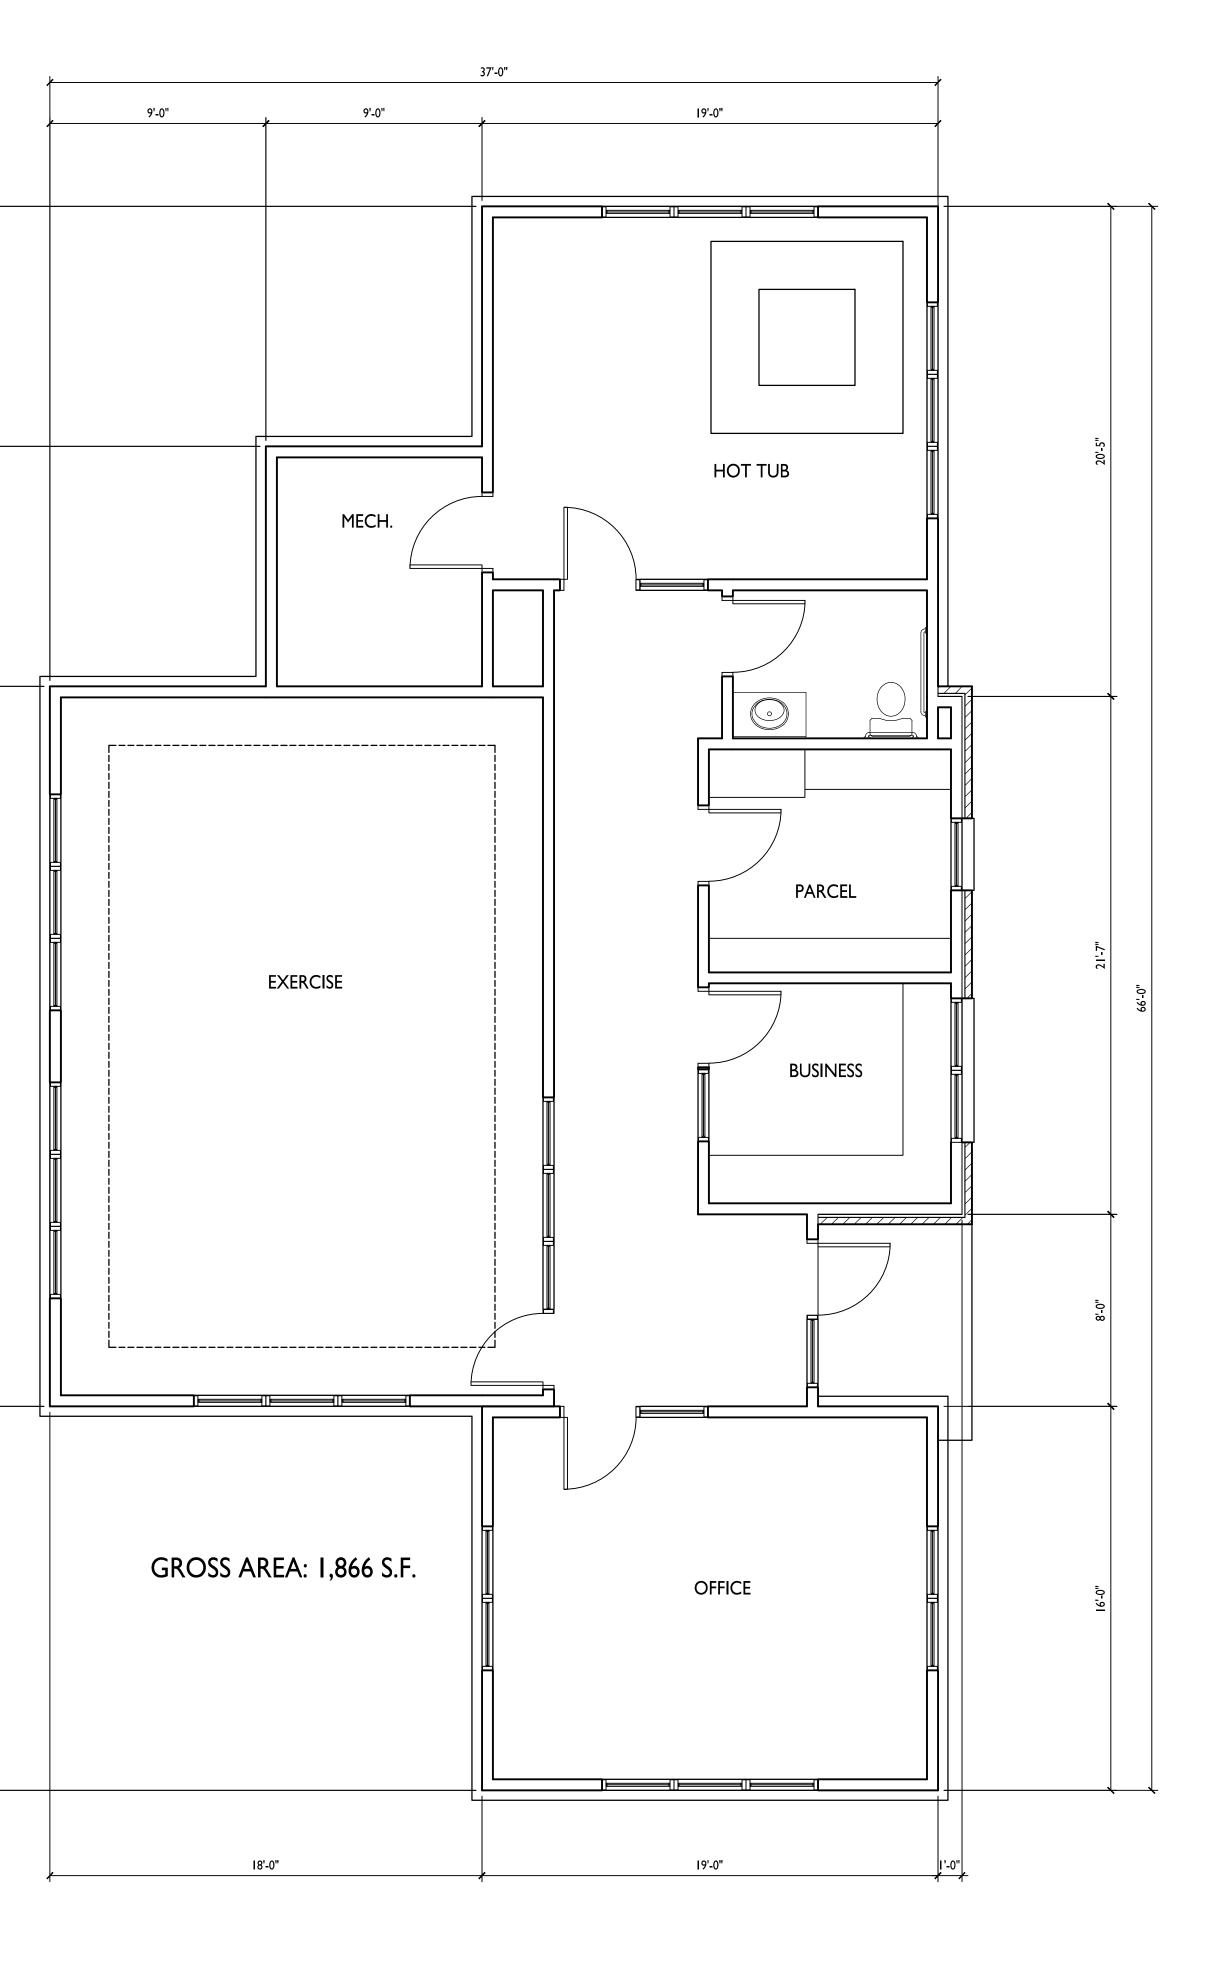





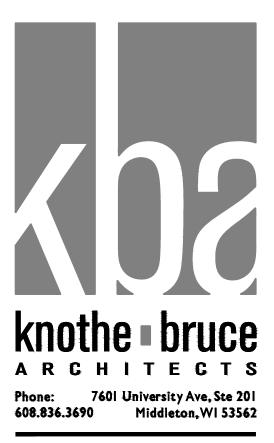


ISSUED Issued To Westport - Jan 26, 2022

PROJECT TITLE LAKEPOINTE APARTMENTS COMMON SPACE ALTERATIONS

5324 Westport Rd. SHEET TITLE Building A Office/Exercise Floor Plan


SHEET NUMBER


A-I.la PROJECT NO. 2147 © Knothe & Bruce Architects, LLC

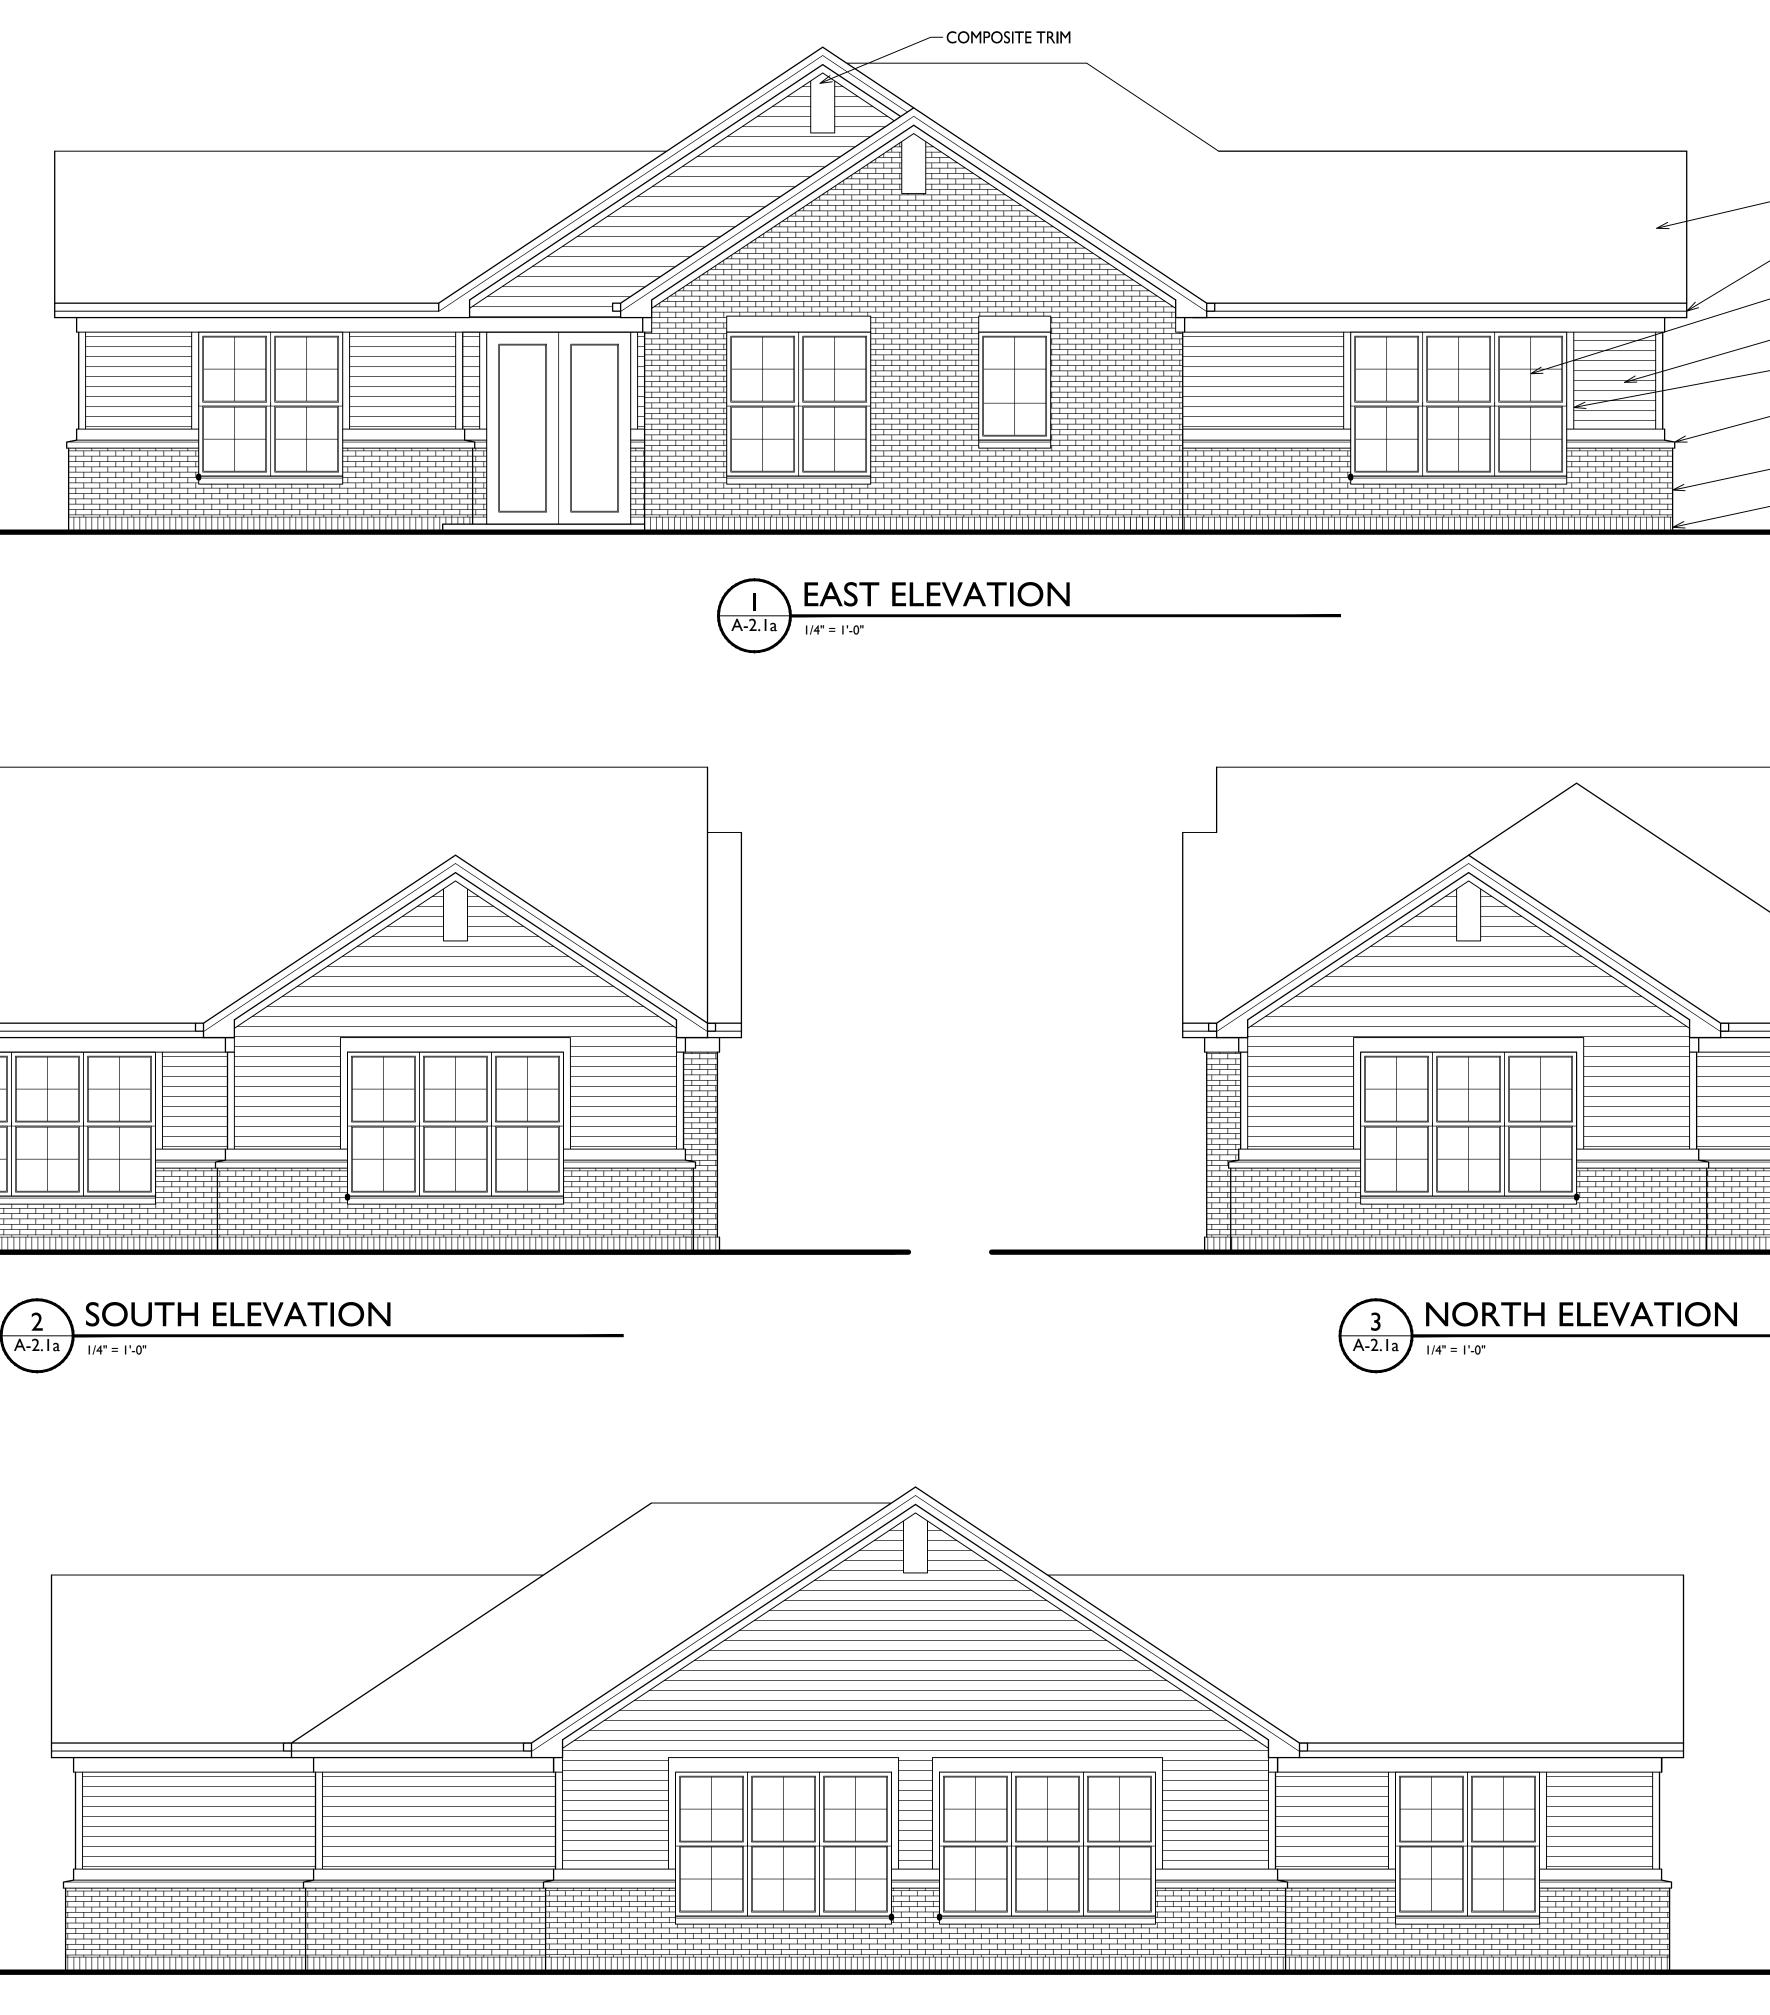





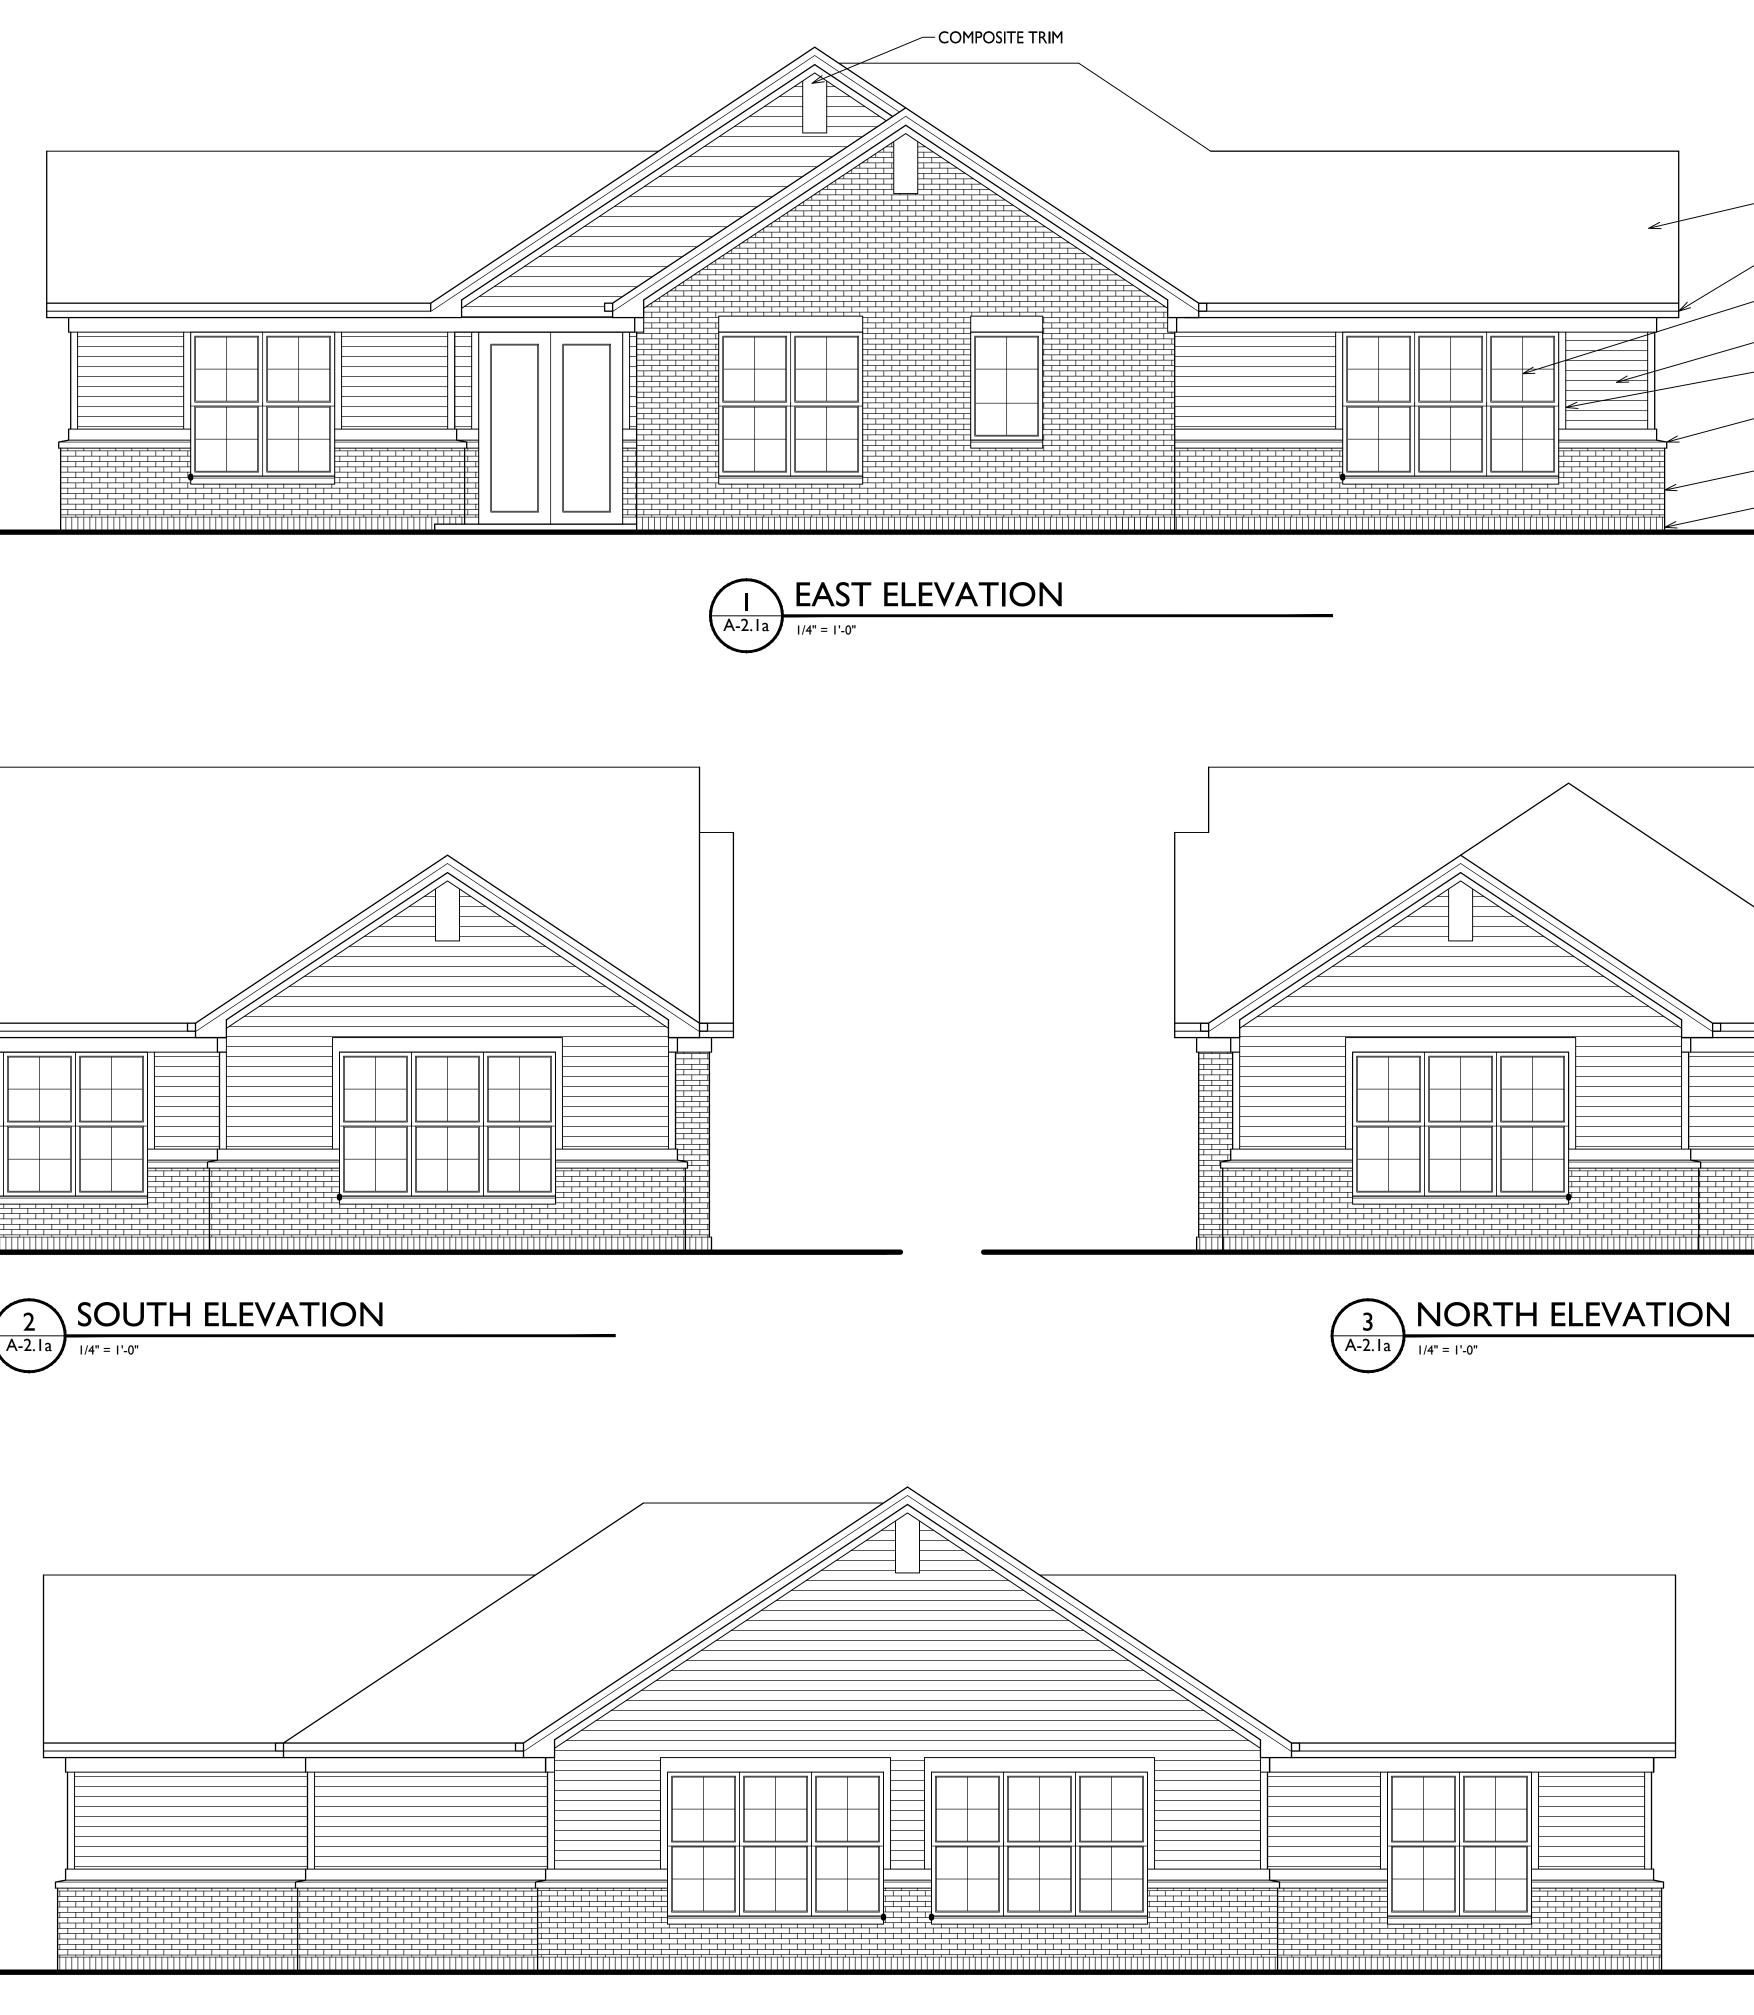

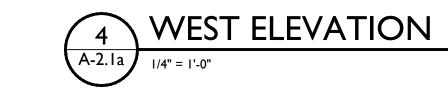

- APSHALT SHINGLES - ALUM. WRAPPED FASCIA &
- SOFFIT
- VINYL WINDOWS
- ALUM. HORIZONTAL SIDING, MATCH EXISTING
- COMPOSITE TRIM
- PRECAST SILLS & WINDOW HEADS
- -BRICK VENEER
- -BRICK SOLDIER COURSE





ISSUED Issued To Westport - Jan, 26, 2022

# PROJECT TITLE LAKEPOINTE APARTMENTS COMMON SPACE ALTERATIONS


5324 Westport Rd. SHEET TITLE Building A **Office/Exercise** Exterior Elevations


SHEET NUMBER

A-2.1a PROJECT NO. 2147

© Knothe & Bruce Architects, LLC




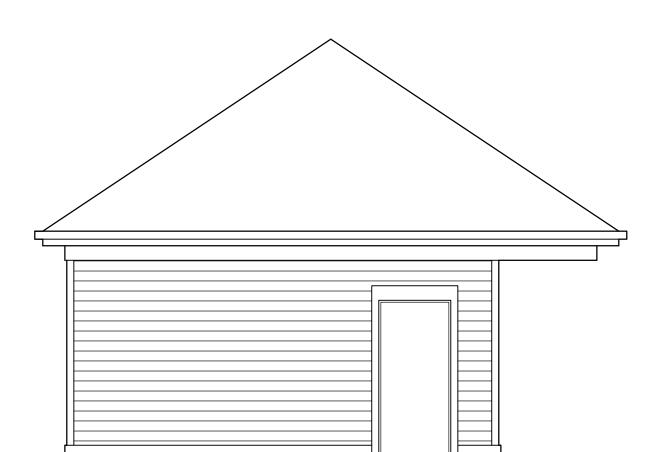

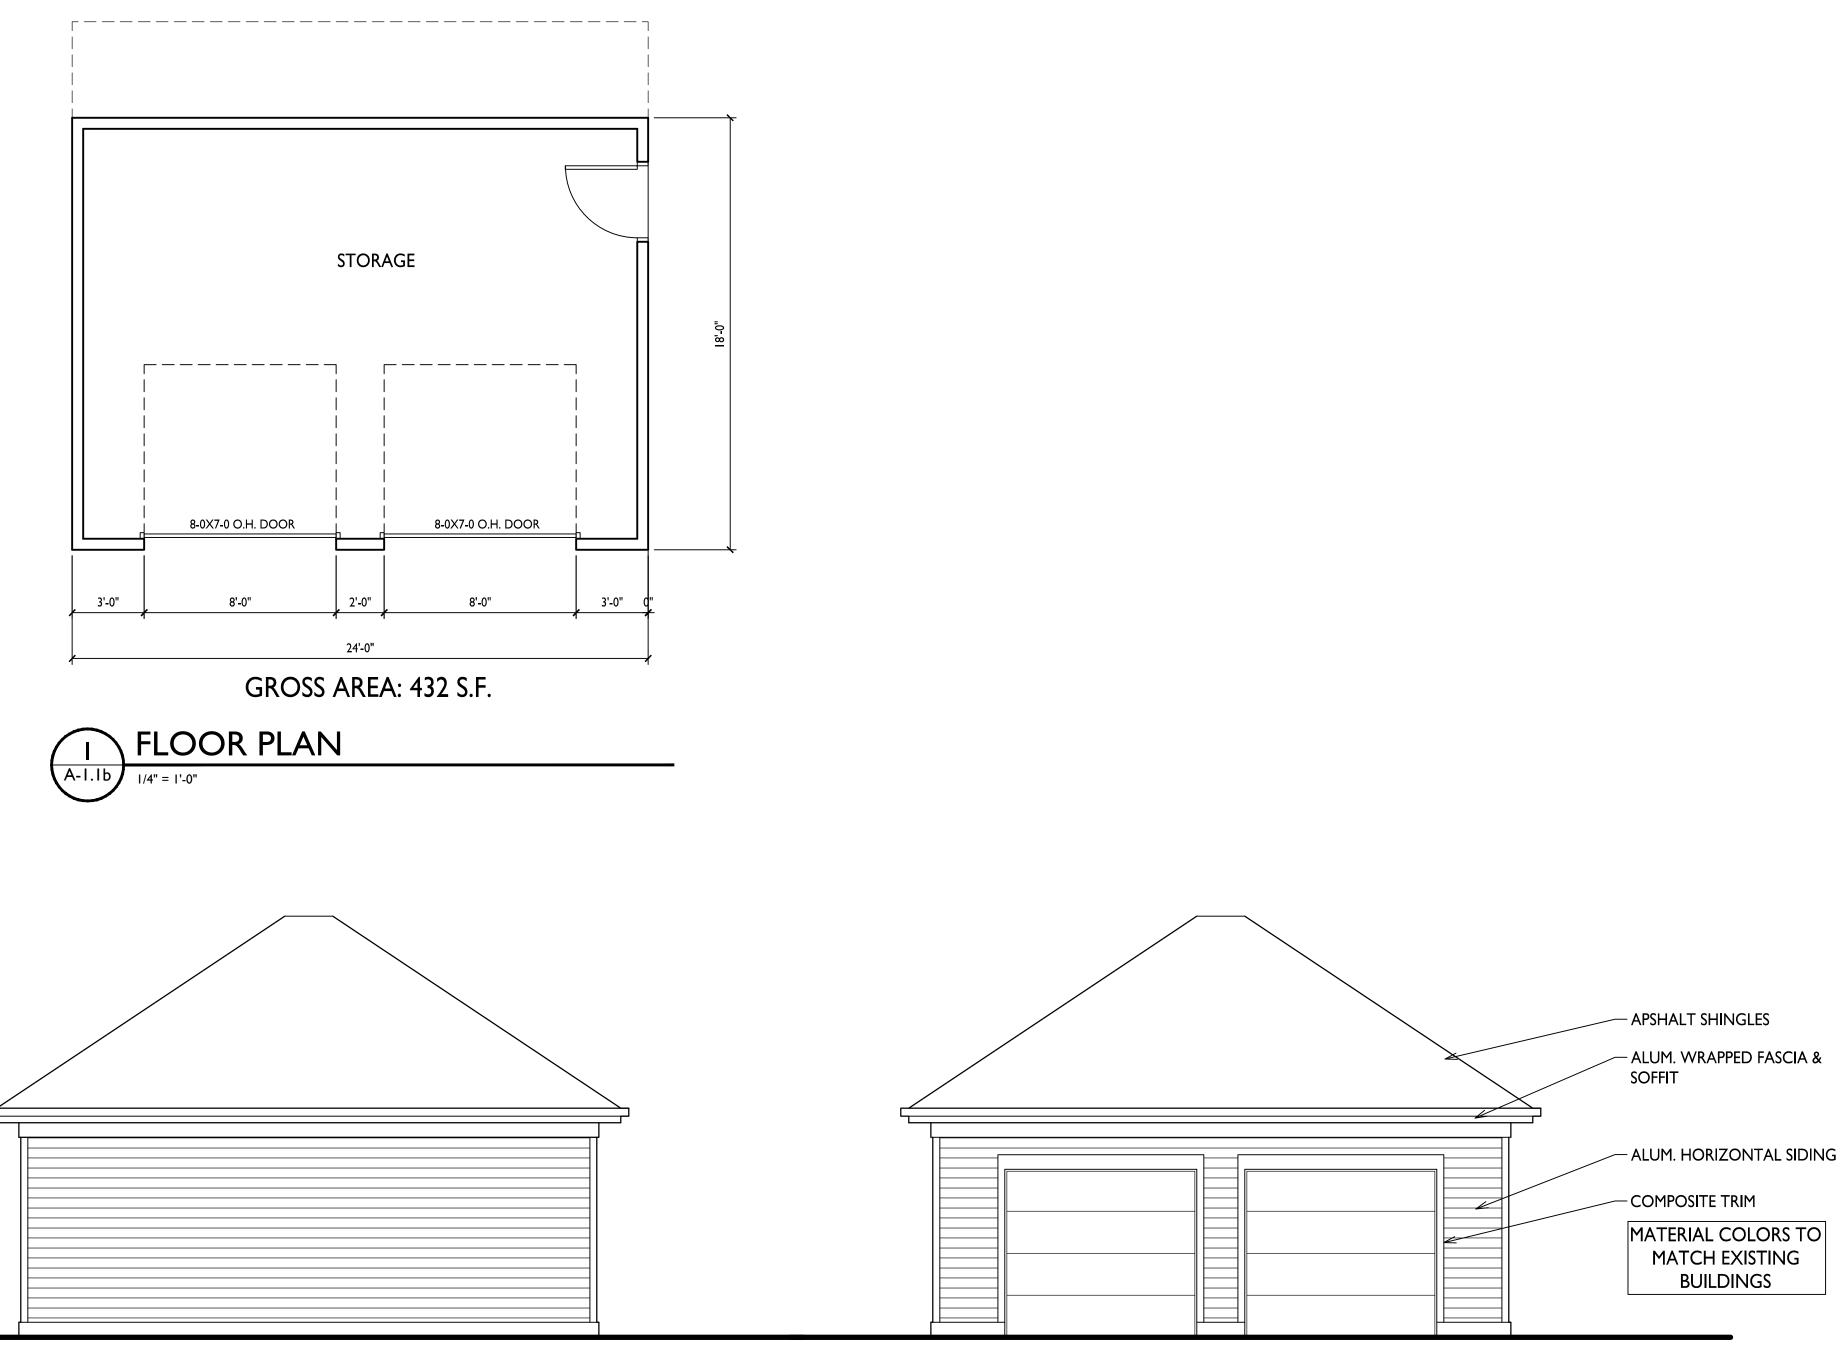





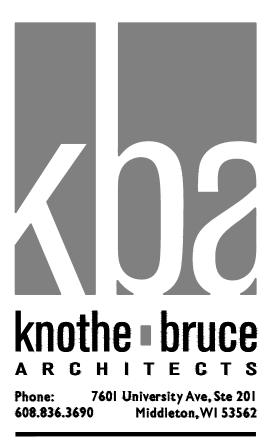



ISSUED Issued To Westport - Jan. 26, 2022


PROJECT TITLE LAKEPOINTE APARTMENTS COMMON SPACE ALTERATIONS

5324 Westport Rd. SHEET TITLE
Building B Storage Shed Plan And Elevations

SHEET NUMBER

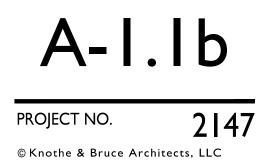

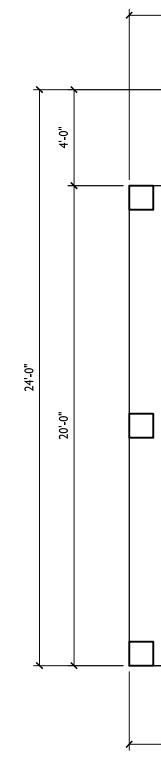

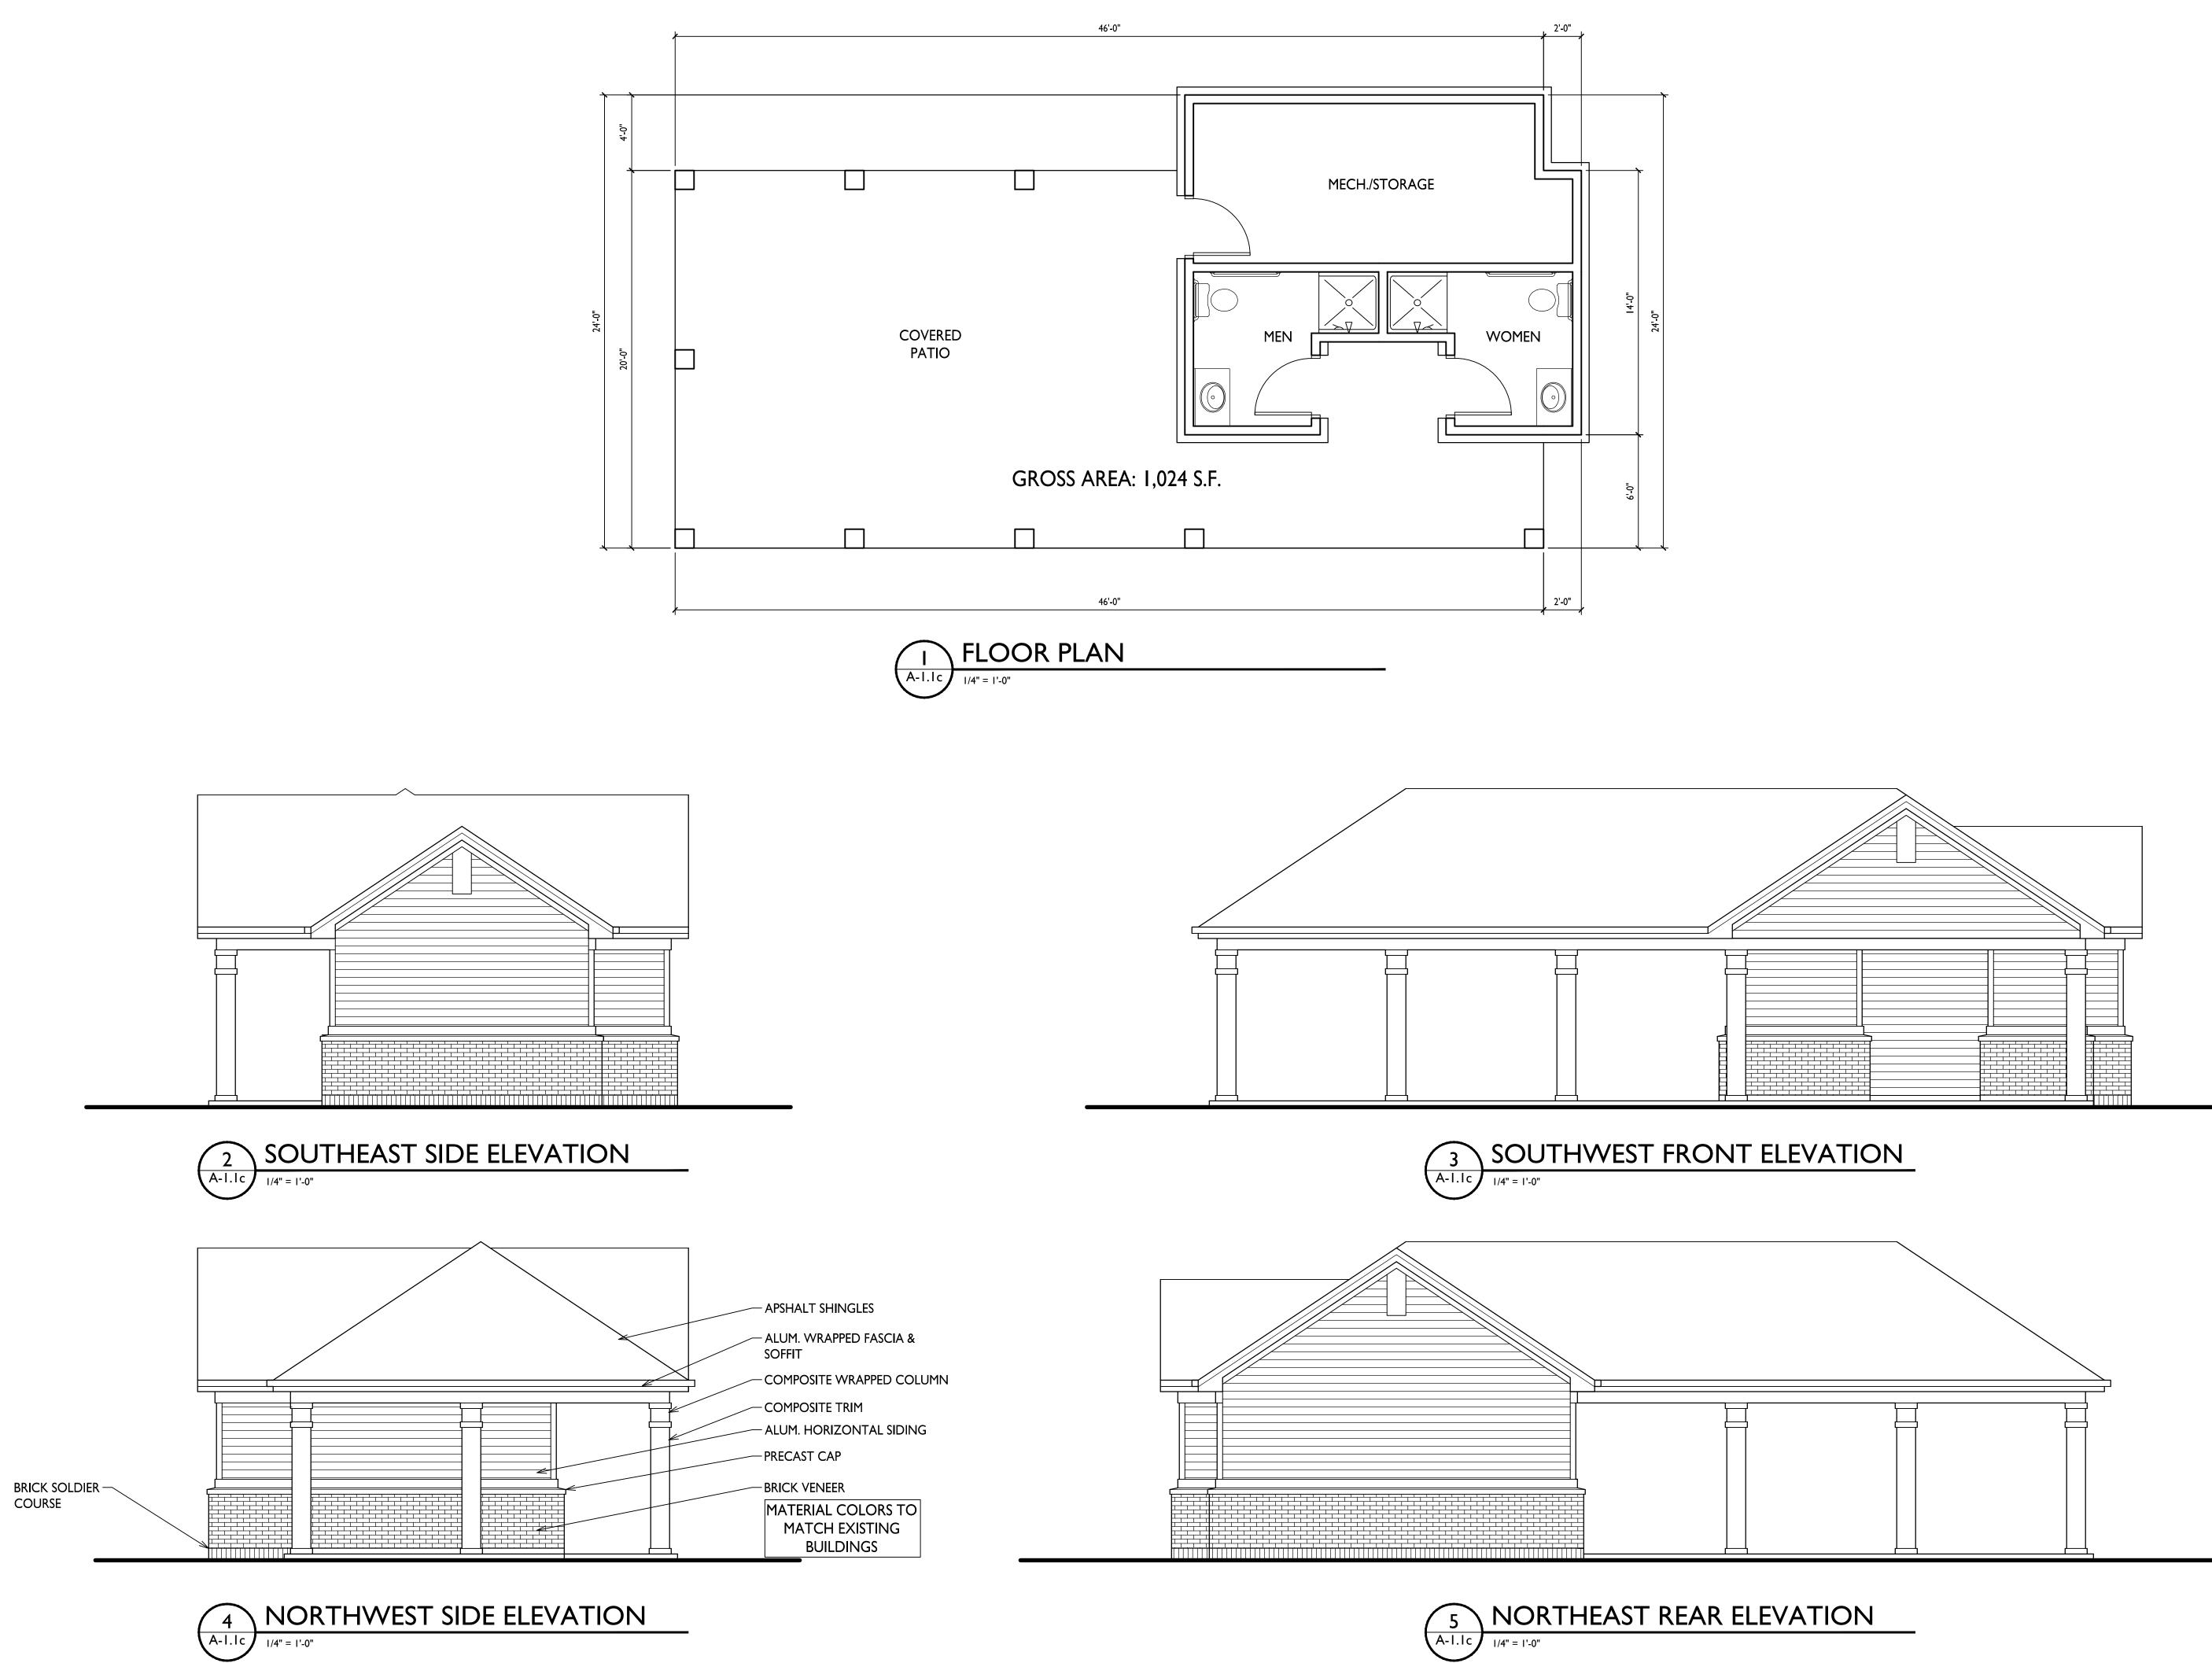




ISSUED Issued To Westport - Jan. 26, 2022

PROJECT TITLE LAKEPOINTE APARTMENTS COMMON SPACE ALTERATIONS


5324 Westport Rd. SHEET TITLE Building C Pool House Plans And Elevations

SHEET NUMBER




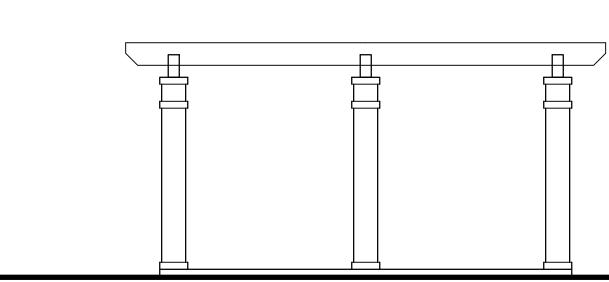




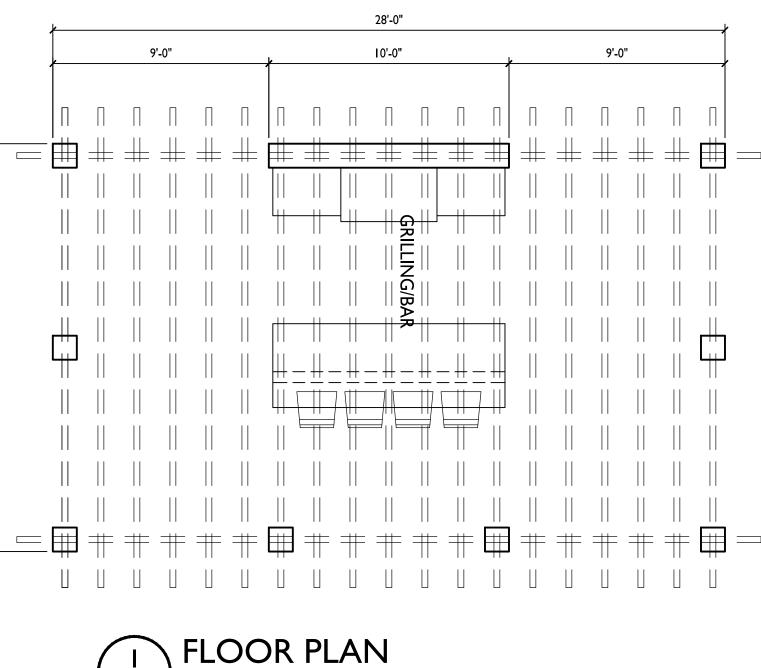

A-1.1d 1/4" = 1'-0"

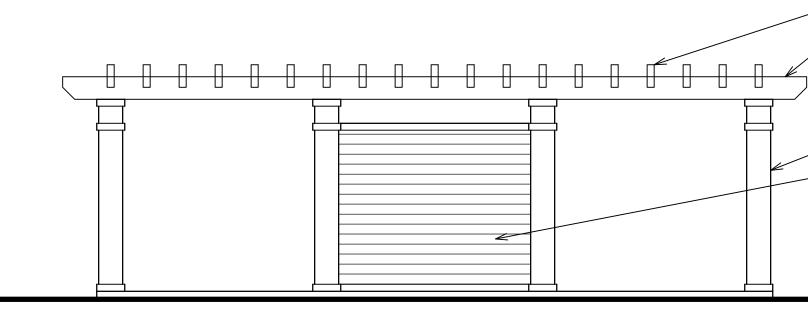



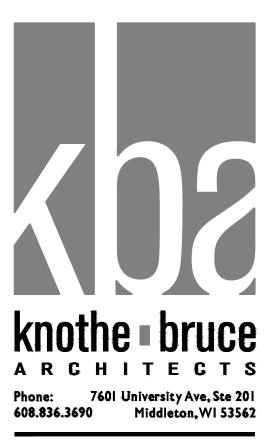

ISSUED Issued To Westport - Jan. 26, 2022

PROJECT TITLE LAKEPOINTE APARTMENTS COMMON SPACE ALTERATIONS

5324 Westport Rd. SHEET TITLE Building D Grilling/Bar Shelter Plan And Elevations

SHEET NUMBER



4x12 HEAVY TIMBER @ 18" O.C. 6x12 HEAVY TIMBER

MATERIAL COLORS TO MATCH EXISTING BUILDINGS



## AGENDA ITEM #5:

Consultation, Land Division and Rezone (Create 2-3 Single Family Residential Lots), Nonn, Wegenke Property Near Briggs Road, CTH Q (Middleton ETZ)



Town of Westport GIS

0

Town of Westport 5387 Mary Lake Road Waunakee, WI 53597 (608) 849-4372

DISCLAIMER: The Town of Westport does not guarantee the accuracy of the material contained here in and is not responsible for any misuse or misrepresentation of this information or its derivatives.

SCALE: 1 = 380'

Print Date: 2/9/2022

#### Lucke/Nonn Property

Town of Westport/City of Middleton,

Thank you for taking the time to date in helping us get this request to you. Attached you will see two proposals for the land that was formerly owned by Mr. Wegenke right off Hwy Q. The total site consists of roughly 8 acres of land. The buildable acres are roughly 4 acres which is situated on the eastern side of the property. In order to get up to the land we will have to have a road that gets us up to the buildable acres. We are proposing having a private asphalt driveway that would get us up to that land. We'd propose a similar width to what is already approved just up the street on Briggs Road which is between 18-20' wide. We'd also like to have a gate at the entrance from Hwy Q. Please see the attached plans that Vierbicher did for us.

Once we got up to the buildable 4 acres of land one plan was splitting the land into two parcels with each being roughly 2 acres in size. This is our preference as this will be the personal residences for both families. The other plan included 3 parcels with lot sizes of 1.4 acres, 1.35 acres and .93 acres. The boxes on the different parcels are where I believe the best placement would be for each house. Ideally, we'd like the 2 parcels option but also included the 3-parcel option as well in case cost overruns make the 2 parcels not feasible.

In order to keep costs down we are proposing having a well/septic on each of the two lots. We already completed a perc test and the results came back good. Additionally, the lot closest to the west that connects via Briggs Road also has a well/septic system according to Meinholz Excavating who did the perc test for us. This would keep it consistent with what is already being allowed in the neighborhood. We also included an attachment with where we'd roughly put the driveways however this hasn't been finalized.

Lot 1 - Driveway to follow along the existing cleared path to maintain as many existing living trees as possible. Additional trees to be planted along the West side of the driveway to create more privacy as well as a light block for neighboring property. Current drawing represents proposed concept, dimensions and exact layout not finalized. Will need to have some trees removed in order to have well/septic for the house.


Lot 2: Driveway to follow more to the east side of the lot to maintain as many existing living trees as possible. Additional trees to be planted along the East side of the driveway to create more privacy from the golf course. Current drawing represents proposed concept, dimensions and exact layout not finalized. Will need to have some trees removed in order to have well/septic for the house.


Having both grown up in the country this property gives our families the best of both worlds. Close amenities of the city but being able to have some privacy and reminding us of where we grew up in the country. The idea would be to build two nicer houses on this amazing piece of property which would both be situated on the north side of the lots at the highest point of the land. While the view is great our other goal was to maintain some privacy which is the reason we purchased this land. So while some trees may have to be taken down our intent would be to replant new trees to continue to give us the privacy we'd be looking for. We appreciate your time and consideration.


Adam Nonn & Cory Lucke






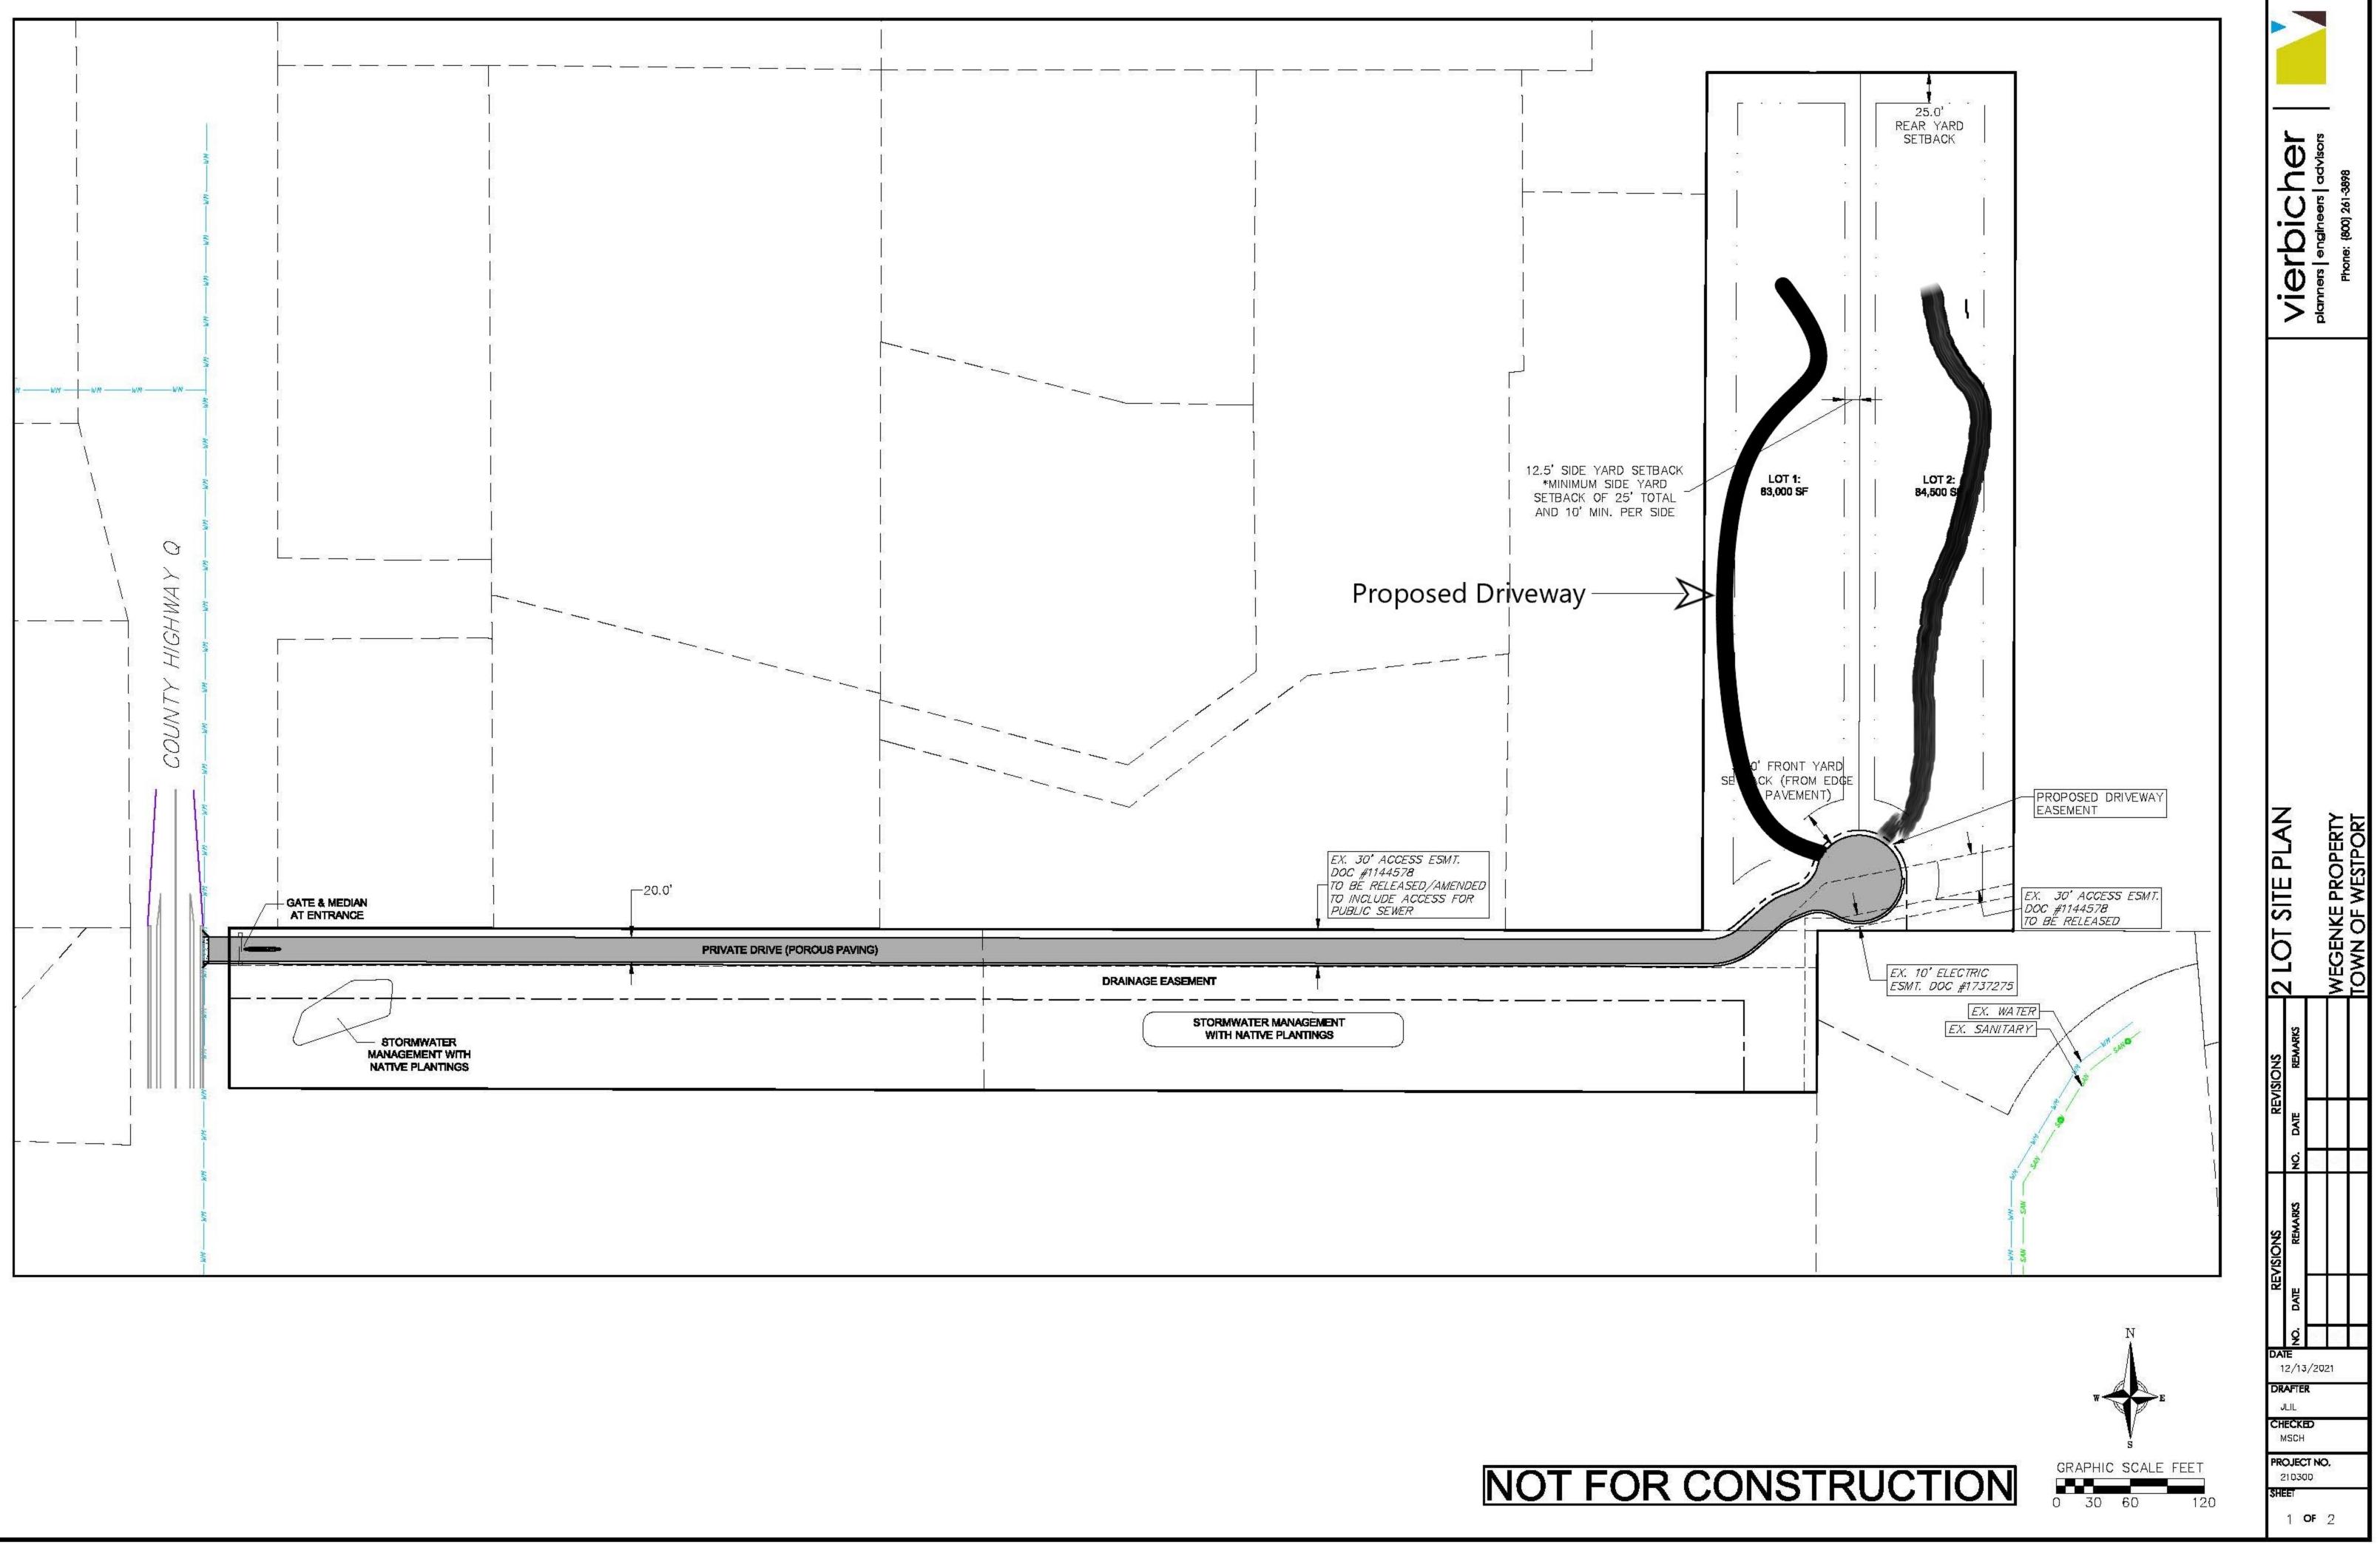

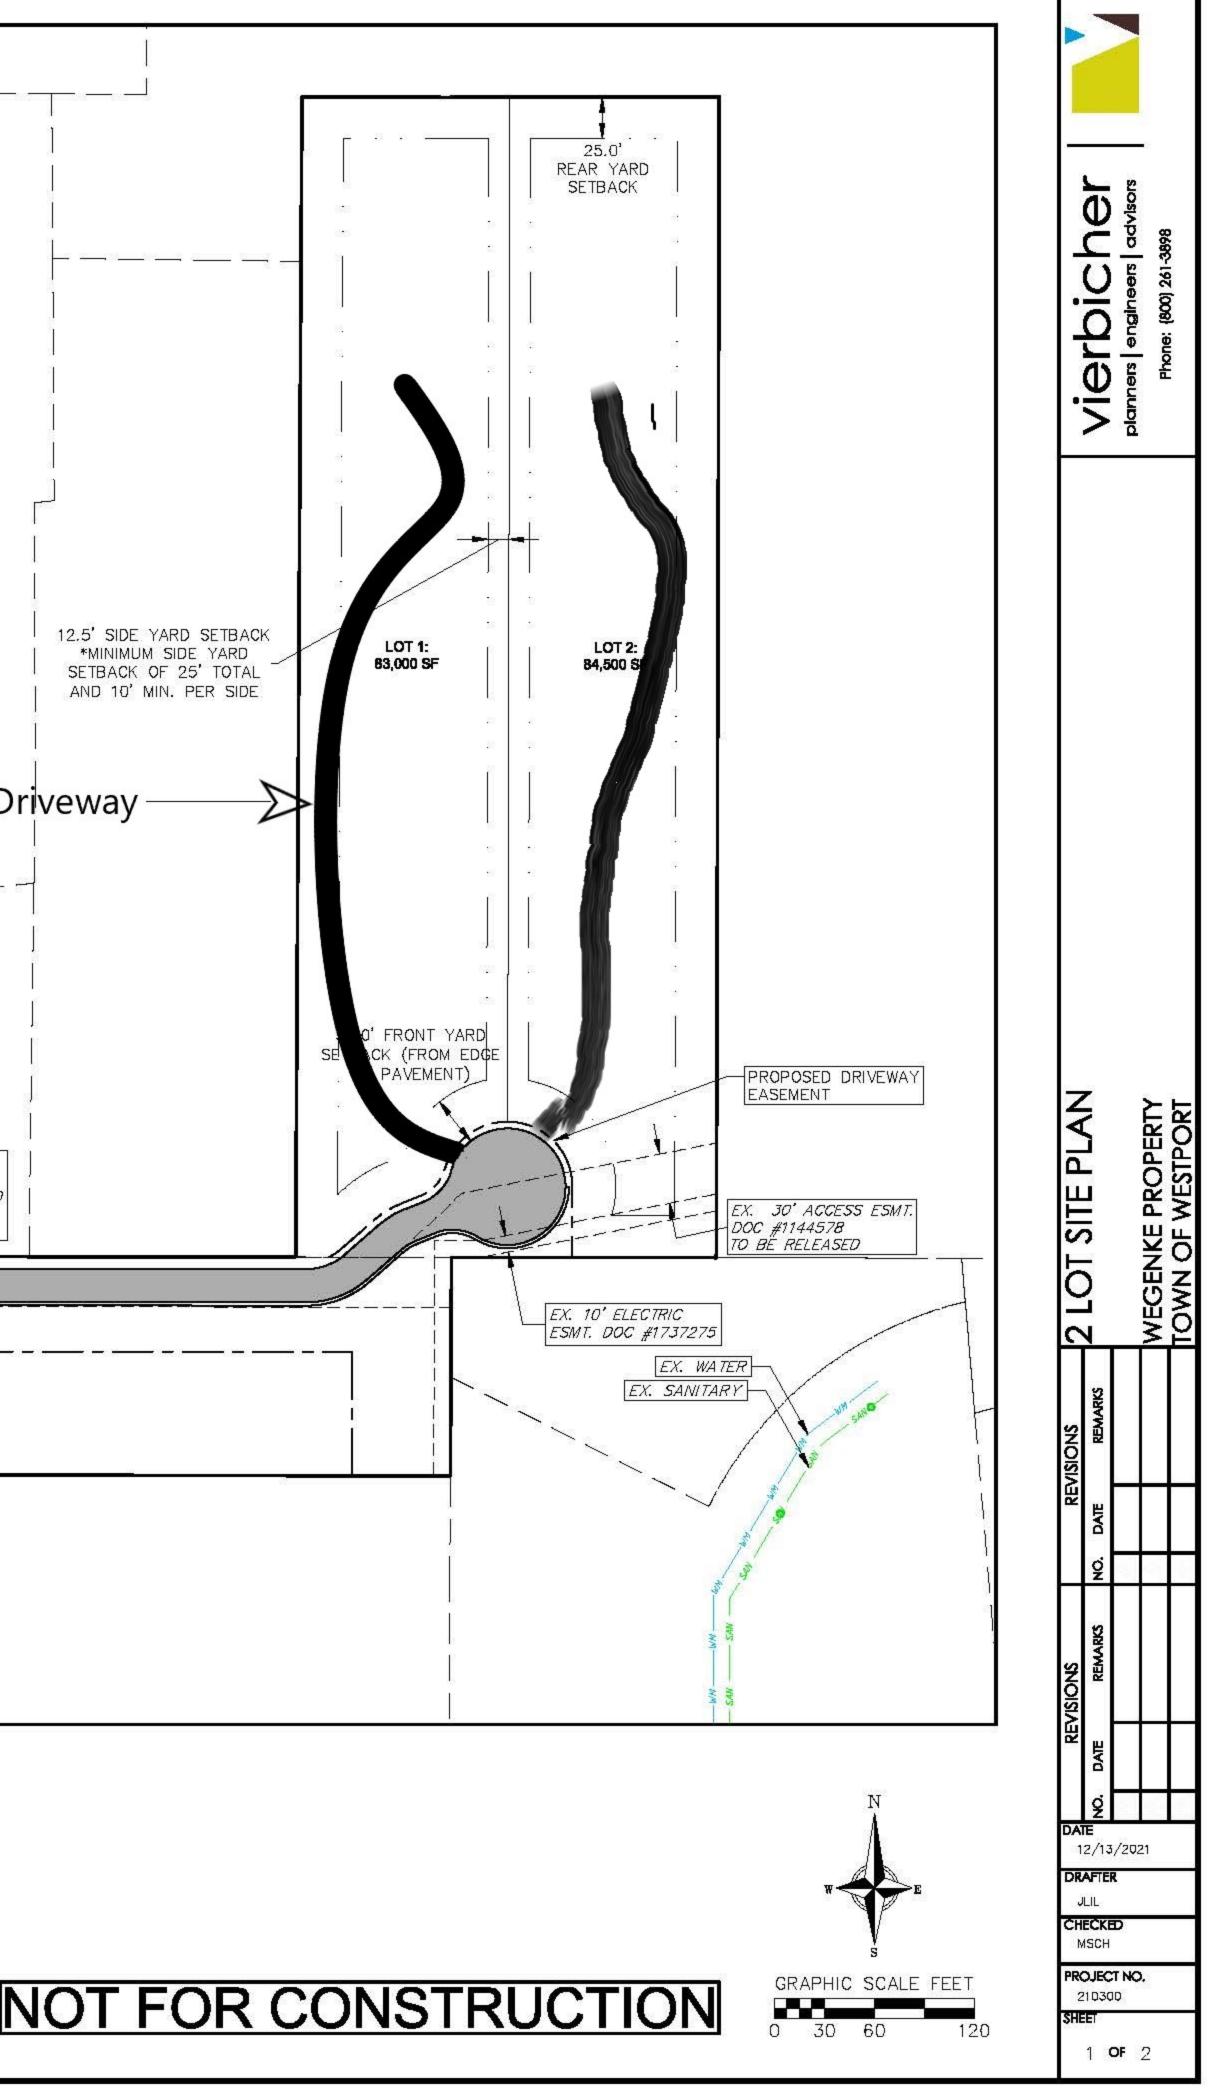


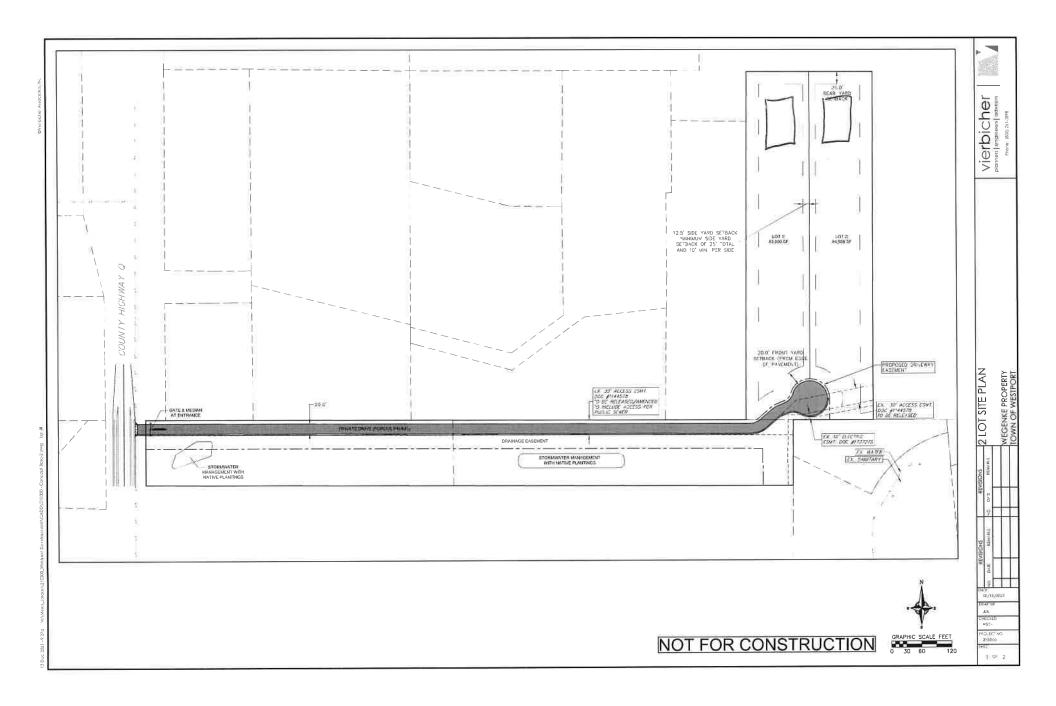


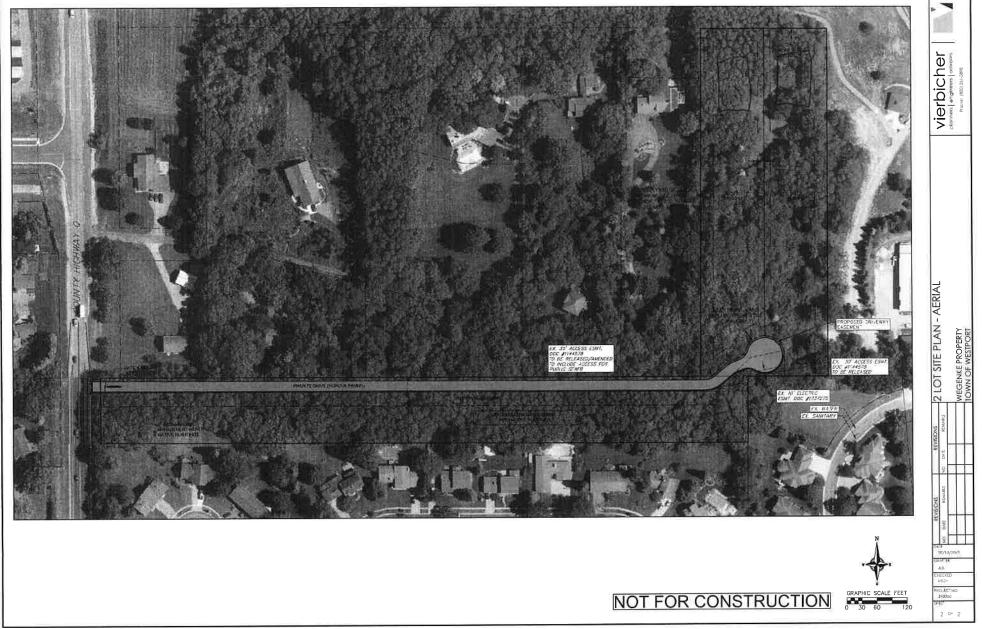

Vierbicher Associates, Inc.

Duc 2021 + 9-38.1 M. \. Mover\_Jaraan/210300\_Watpari Developmeni/CADD/210300 + Concopi Baae-2 dvg Dr. M

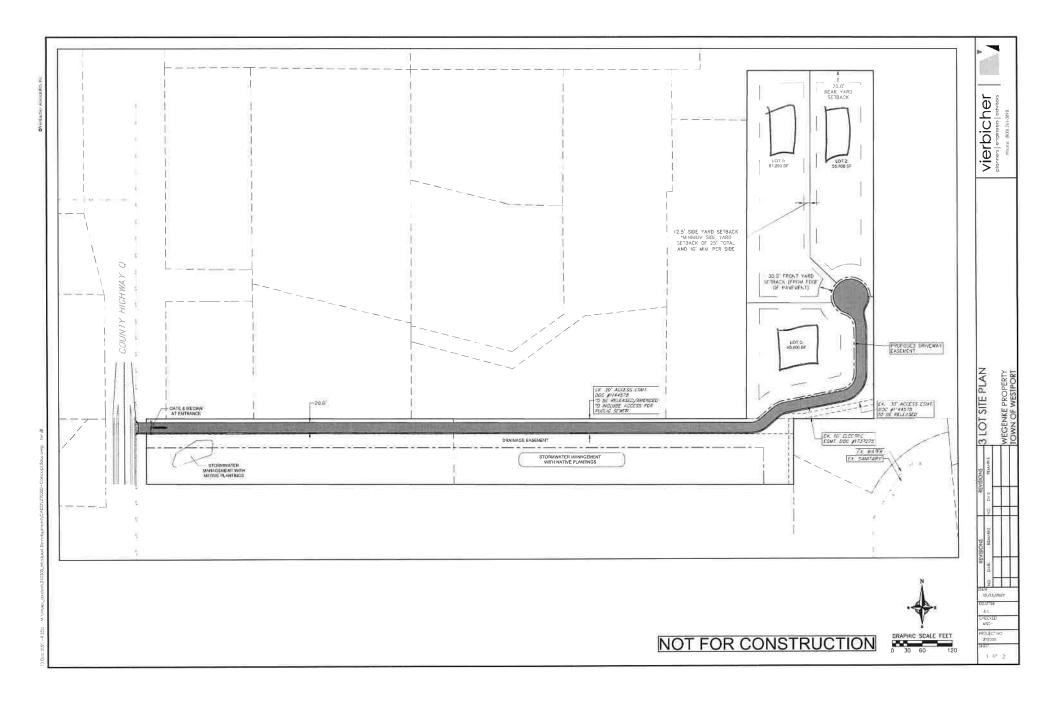

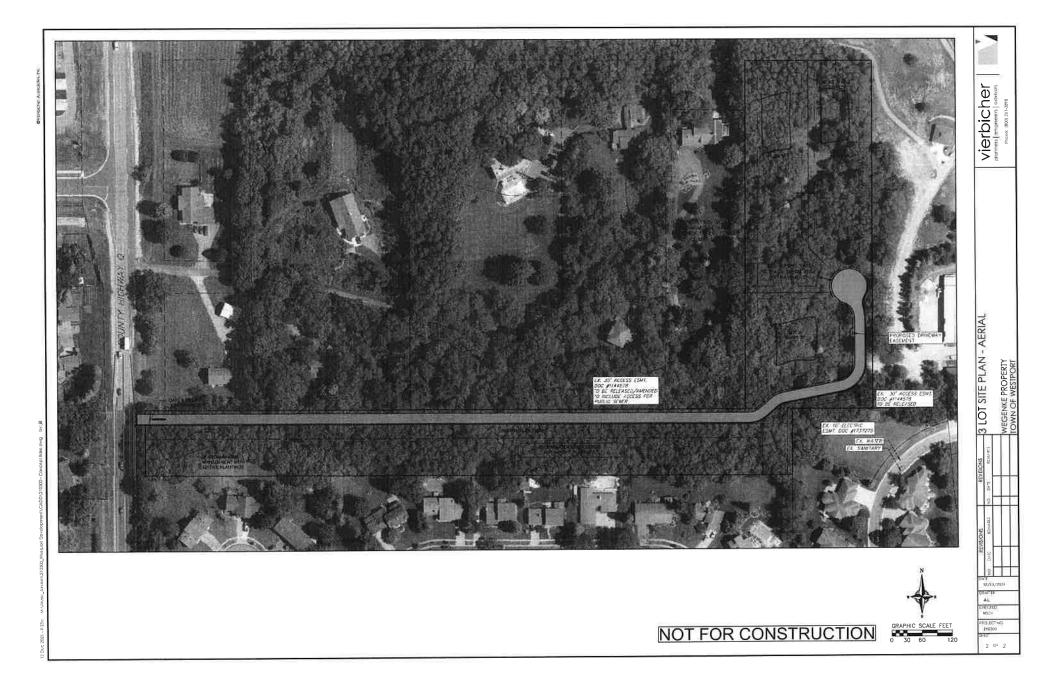

Wisconsin Department of Safety and Professional Services

LOT 1

Page <u>1</u> of <u>6</u>

Division	of Industry Se	ervices		SOIL E	evalua <sup>.</sup>	TION REP	ORT	P	Roposo	LOT.	1	
			Ir	accordance wit				County	1			
Attach complete site plan on paper not less than 8 1/2 x 11 inches in size. but not limited to: vertical and horizontal reference point (BM), direction ar scale or dimensions, north arrow, and location and distance to nearest roa					in size. Pla tion and p	in must inclu	le,	DANE Parcel 0809-3				
Please print all information.								Review	ved by		Dat	te
Personal infe	ormation you	provide may be use	d for sec	ondary purposes	s (Privacy L	aw, s. 15.04(	1)(m)).	l				
Property Ow					Pr	operty Locat	on				$\boxtimes$	
John Weger	ike-owner. F	Purchaser = Adam	Nonn/ L	ucke 608-609-0	196 Go	ovt. Lot SE	14 SE 1/			(or) W		
Property Ow	mer's Mailing	g Address			Lo	ot #	Block #		ubd. Name or CS		_ %	
	ton Beach R				1				relim CSM-PROP			
City		State Zip	Code	Phone Nu	mber 🛛	] City	🔲 Villa		Town	Neares		
Middletron		WI 53	562	()				V	VESTPORT	CTH "C	<u>Į"</u>	
New Cor Replace Parent mate General con	ement rial Loess ov		ommerc	ial – Describe: _	Flo	od Pian elev	ation if a	pplicable	<u>N/A</u> ft.			
1 Boring	#	Pit	C	Ground surface e	elev. <u>93.1</u> fl	t. Depth to lin	niting fac	tor <u>94+</u> i:	n.			
											Soil Appli	cation Rat
Horizon	Depth	Dominant Color	Redo	x Description	Texture	Structure	e Co	onsistenc	e Boundary	Roots	GP	D/Ft <sup>2</sup>
TIONZON	In.	Munsell	Qu. A	z. Cont. Color		Gr. Sz. S	h,				*Eff#1	*Eff#2
1	0-12	10YR 3/3	none		sil	2msbk	m	fr	cs	3m	0.6	0.8
2	12-22	10YR 4/3	none		scl	2msbk	m	fr	cs	2m	0.4	0.6
3	22-40	7.5YR 4/4	none		scl	2msbk	m	fr	cw	2m	0.4	0.6
4	40-94	10YR 6/4	none	-	sl	1mpl	m	fr		12"1f	0.4	0.6
2 Boring	) <i>#</i>	☐ Boring ⊠ Pit		Ground surface	elev. <u>91.3</u> f	ft. Depth to lin	niting fa	ctor <u>94+</u>	in,		Soil Appl	ication Ra
	1		_		-	0: 1		onsisten	ce Boundary	Roots		PD/Ft <sup>2</sup>
Horizon	Depth In.	Dominant Color Munsell	Qu. A	ox Description z. Cont. Color	Texture	Structur Gr. Sz. S	- 1	ULUISISICI			*Eff#1	*Eff#2
1	0-8	10YR 3/3	none		sil	2msbk	m	fr	CS	3m	0.6	0.8
2	8-21	10YR 4/3	попе		scl	2msbk	m		CS	2m	0.4	0.6
3	21-37	7.5YR 4/4	none		scl	2msbk	m	fr	CW	2m	0.4	0.6
	37-94	10YR 6/4	none		sl	1mpl	m	fr		12"1f	0.4	0.6
4	31-84		none									
,	Effluent #1 =	= BOD, > 30 ≤ 220 r	ng/L an		0 mg/L	* Efflu	ent #2 =		30 ≤ 220 mg/L and	d TSS > 3	0 ≤ 150 mg/	L
	(Please Prin		llorer	Signature Ru	Jul 1	5 Her	w		ST Number 1536			
	Soil Testing,	LLC. / Richard C.	Herro	Date Evaluatio	n Conduct		7.173		elephone Number	r		
Address 603 N Dev	ev Avenue	Jefferson, WI5354	.9	12-21-2021	Gonddol				20-650-6788. EN		ro54@gmail	.com
JUD N. DEW	oy Avoince, i	0000									SBD-83	30 (R04/

SBD-8330 (R04/15)

PAGE 2 OF 6

	Boring
$\boxtimes$	Pit

Ground surface elev. 96.3 ft. Depth to limiting factor 94+ in.

				GE	Soil Appli	cation Rate				
	Death	Dominant Color	Redox Description	Texture	Structure	Consistence	Boundary	Roots	GP	D/Ft <sup>2</sup>
Horizon	Depth In.	Munsell	Qu. Az. Cont. Color		Gr. Sz. Sh.	-			*Eff#1	*Eff#2
1	0-8	10YR 3/3	попе	sil	2msbk	mfr	CS	3m	0.6	0.8
2	8-18	10YR 4/3	none	sci	2msbk	mfr	CS	2m	0.4	0.6
3	18-38	7.5YR 4/4	none	scl	2msbk	mfr	cw	2m	0.4	0.6
4	38-94	10YR 6/4	none	sl	1mpl	mfr		12"1f	0.4	0.6
										1

Boring #

Boring

Ground surface elev. \_\_\_\_\_ ft.

Depth to limiting factor \_\_\_\_\_ in.


									Soil Applic	ation Rate
Ussinan	Death	Dominant Color	Redox Description	Texture	Structure	Consistence	Boundary	Roots	GPD/Ft <sup>2</sup>	
Horizon	Depth In.	Dominant Color Munsell       Redox Description Qu. Az. Cont. Color       Texture Consistence       Consistence       Boundary       Roots       Original         Image: Structure Qu. Az. Cont. Color       Image: Structure Gr. Sz. Sh.       Image:	*Eff#1	*Eff#2						
							1			


		∐ Pit	Ground surface			Consistence	Boundary	Roots	Soil Applic	cation Rate
Horizon	Depth In.	Dominant Color Munseli	Redox Description Qu. Az. Cont. Color	Texture	Structure Gr. Sz. Sh.	Consistence	Boundary		*Eff#1	*Eff#2
				· · · · · · · · · · · · · · · · · · ·						
									-	

\* Effluent #1 = BOD, > 30  $\leq$  220 mg/L and TSS > 30  $\leq$  150 mg/L


\* Effluent #2 = BOD, > 30  $\leq$  220 mg/L and TSS > 30  $\leq$  150 mg/L


Boring # 4

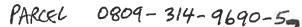

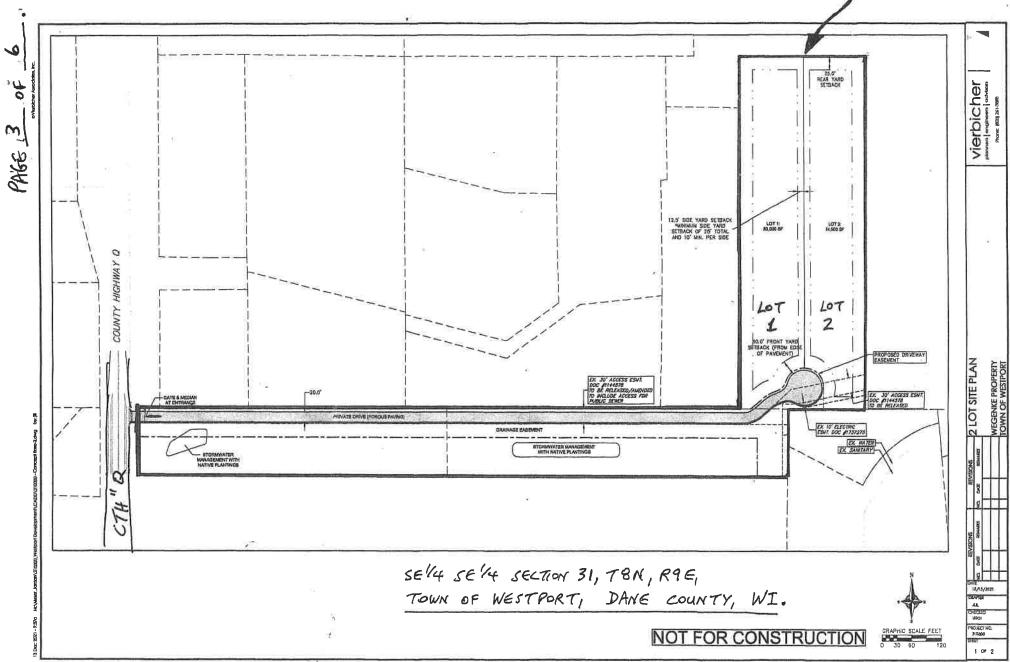

.

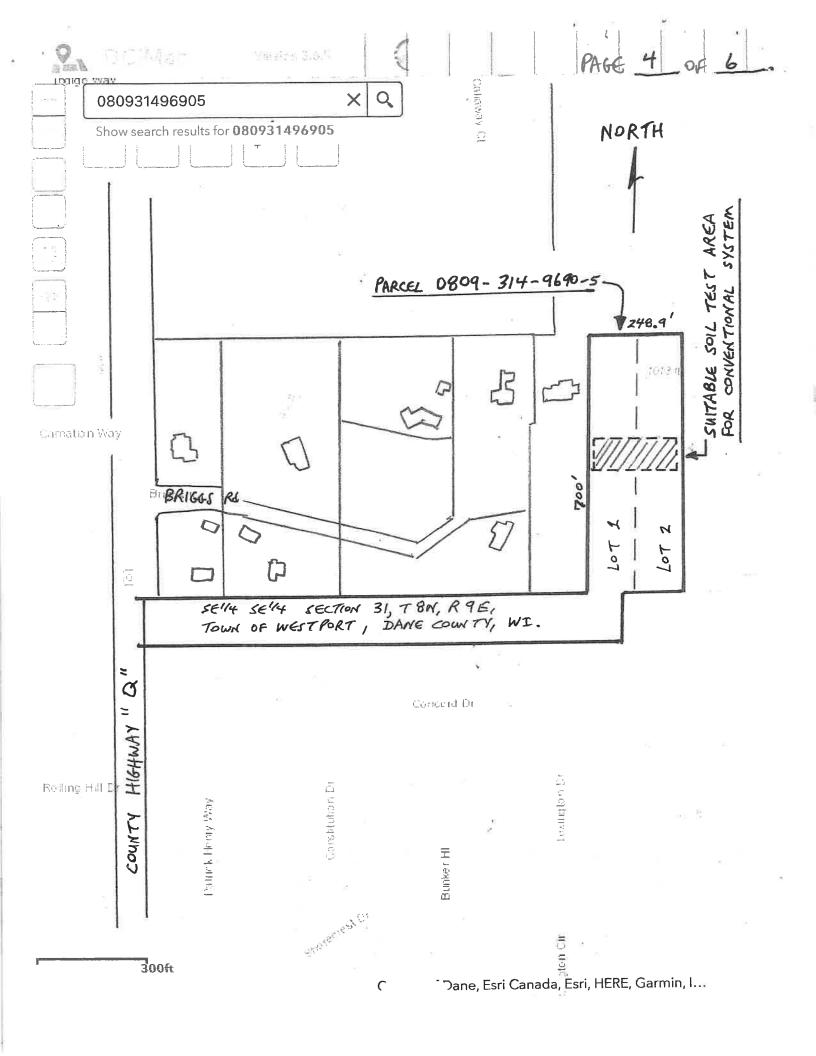

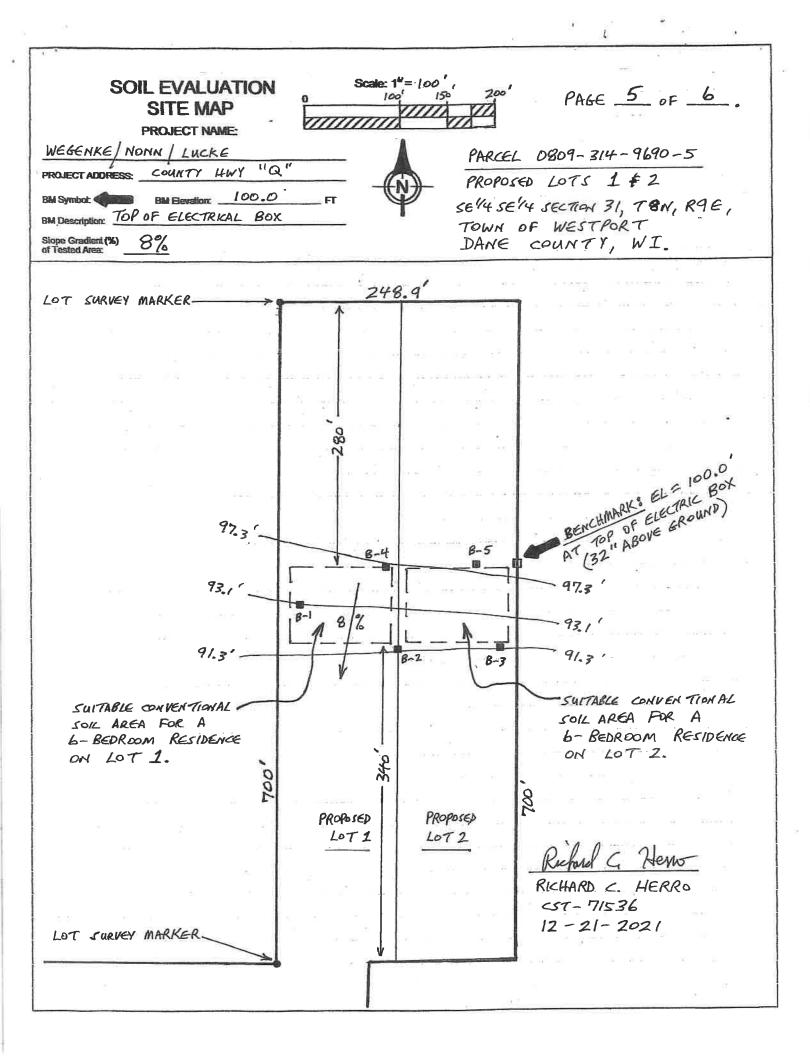

CHECK BOX AS APPLICABLE. CHECK BOX AS APPLICABLE. PAGE 6 OF 6 SOIL EVALUATION Scale: 1" = 40' SYSTEM 40 60 80 SITE MAP PLOT PLAN 900 PROJECT NAME: **DESIGN FLOW:** GPD 10<sup>2</sup> Attach design flow calculations for commercial plans. WEGENKE NONN LUCKE "Q" Pipe Material / ASTM Standard (Tables 384.30-3 & 384.30-5) HWY PROJECT ADDRESS: COUNTY Sanitary Sewer:\_\_\_\_ 100.0 **BM Elevation:** ΕT BM Symbol: Force Main: BM Description: TOP OF ELECTRICAL BOX SOIL LOADING RATE=0.4 IMPORTANT: Indicate north by Slope Gradient (%) of Tested Area: 8% Show ground elevation contours at suitable intervals. Well Symbol (if applicable): O drawing an arrow on the approprite line. NORTH LOT LINE 124.4' -124.4'-PROPOSED LOT 2 PROPOSED LOT PRIMARY SITE = (6) 3'x 75' PRIMARY SITE = (6) 3 x 75 EZ-FLOW CELLS. 700' 700 EZ-FLOW CELLS. E.I.S.A. = 2250 SQ. FT. E.I.J.A = 2250 SQ. FT 280 RESERVE SITE = SAME RESERVE SITE = SAME. SYSTEM ELEVATION DATA WCHIMARK: EL= 100.0 0 POR BOTH LOTS: CELL-1 = 92.0 EALT LOT LINE CELL- 2= 91.5 OF ELECTRICK CELL-3= LELL-4= 91.0 LINE 90.5 90.0 LELL-5= 2611-6 = 107 89.5 CELL-7= 99.0 88.5 WEST CELL-9= 88.0 LELL- 10 = 87.5 LELL- 11= 87.0" LELL- 12= 86.5" 8-4 B-5 3 🗐 5 2 ŝ 20 3 Q0 96.5 4 5 5 6 6 B-l 17 7 8 B 9 9 93.11 10 10 11 11 12 12 91,3' 8-2 B-3 340 TO Heno SOUTH LOT LINE RICHARD C. HERRO 12-21-2021 CST-71536

Wisconsin Department of Safety and Professional Services Lot 2 Division of Industry Services

Page	1	of	6

				SOIL	EVALU	ATION RE	PORT	P	ROPOSED	L07	2	
-				In accordance w	ith SPS 3	85, Wis. Adm	. Code	Count	у			
Attach co	mplete site p	lan on paper not le	ss than	8 1/2 x 11 inches	s in size. F	lan must inclu	ude,	DANE				
scale or c	nited to: verti limensions, r	cal and horizontal r north arrow, and loc	eterenc ation ar	e point (BM), dire id distance to ne	ection and arest road	percent slope	Э,	Parce 0809-3	11.D. 314-9690-5			
				information.				Review	wed by		D	ate
Personal in	formation you	ı provide may be us	ed for se	econdary purpose	es (Privacy	Law, s. 15.04	(1)(m)).					
Property Ov						Property Loca	tion				$\boxtimes$	
John Wege	nke-owner.	Purchaser = Adam	Nonn/	Lucke 608-609-	0196 (	Govt. Lot SE	14 SE 1	¼ S 31	T8NR9 8	E (or) W		
	wner's Mailin	0				.ot#	Block #	L =	ubd. Name or C			
City	eton Beach F		p Code	Phone Nu	2 umbor [				relim CSM-PRO		st Road	
Middletron		E 1	562			City	U Villa	- 1% -	Town VESTPORT	CTH "C		
New Cor	estruction	Use: 🛛 Residentia	d / Numi	bosofbodroomo	6 Codo da		Row rate	000.000				
				cial - Describe:		erived design	now rate	<u>900</u> GPL	)			
· ·	rial <u>Loess ov</u>					ood Plan elev	ation if a	policable	N/A ft.			
		ecommendations:						•••				
								-16				
		Boring										
2 Boring	#	Pit 0	I	Ground surface e	elev. <u>91.3</u> t	ft. Depth to lin	niting fac	tor <u>94+</u> in	۱.			
											Soil Appl	ication Rate
Horizon	Donth	Dominant Color	Rode	ox Description	Texture	Structure		onsistence	e Boundary	Roots	1	PD/Ft <sup>2</sup>
Horizon	Depth In.	Munsell		z. Cont. Color	Texture	Gr. Sz. S		naisterio	Boundary	110010	*Eff#1	*Eff#2
1	0-8	10YR 3/3	none		sil	2msbk	mf	r	CS	3m	0.6	0.8
2	8-21	10YR 4/3	none		scl	2msbk	mf	r	CS	2m	0.4	0.6
3	21-37	7.5YR 4/4	none		sci	2msbk	mf	Ť	cw	2m	0.4	0.6
4	37-94	10YR 6/4	none		sl	1mpl	mf	r		12"1f	0.4	0.6
									1			
3 Boring	#	🔲 Boring 🔀 Pit		Ground surface e	alev 913	ft. Denth to lin	niting fac	tor 94+ i	n.			
			·		5104. <u>01.0</u>	n. Depui to in	inding for	<u></u>				
					r	_				<u> </u>		lication Rate
Horizon	Depth	Dominant Color		ox Description	Texture	Structure Gr. Sz. S		onsistence	e Boundary	Roots		PD/Ft <sup>2</sup>
	in.	Munsell			- 11				cs	3m	*Eff#1 0.6	*Eff#2 0.8
1	0-8	10YR 3/3	none		sil scl	2msbk 2msbk	mf		CS	2m	0.4	0.6
2	8-17 17-43	10YR 4/3 7.5YR 4/4	none none		scl	2msbk	mí	_	cw	2m	0.4	0.6
4	43-94	10YR 6/4	none		sl	1mpl	m			12"1f	0.4	0.6
4	43-94	10110.0/4	none		31	- tinpi			-			
							_					
	Effluent #1 =	BOD, > 30 ≤ 220 r	ng/L an	d TSS > 30 ≤ 150	l 0 mg/L	L * Efflue	nt #2 = E	30D, > 3	0 ≤ 220 mg/L and	1 TSS > 30	l ≤ 150 mg/	L .
	(Please Print)			Signature D	00	~ 1			T Number			
		LC. / Richard C. I	Herro	Ku	Kasel	G Ale	115		536			
Address		<b></b>	_	Date Evaluation	n Conduct	ed			lephone Number		54@	
603 N. Dewe	ey Avenue, J	efferson, WI. 5354	9	12-21-2021				92	0-650-6788. EN	ALL: MON		.com 30 (R04/15)

Boring # 4

#### ☐ Boring ⊠ Pit

#### Ground surface elev. 96.3 ft. Depth to limiting factor 94+ in.

							Boundary		Soil Application Rate	
Horizon	Depth	Dominant Color Munsell	Redox Description Qu. Az. Cont. Color		Structure Gr. Sz. Sh.			Roots	GP	D/Ft <sup>2</sup>
	in.							łî.	*Eff#1	*Eff#2
1	0-8	10YR 3/3	none	sil	2msbk	mfr	cs	3m	0.6	0.8
2	8-18	10YR 4/3	попе	scl	2msbk	mfr	CS	2m	0.4	0.6
3	18-38	7.5YR 4/4	none	scl	2msbk	mfr	cw	2m	0.4	0.6
4	38-94	10YR 6/4	none	sl	1mpl	mfr		12"1f	0.4	0.6
									l	

5 Boring #

🔲 Boring 🛛 Pit

Ground surface elev. 97.4 ft. Depth to limiting factor 94+ in.

	1					r			Soil Application R				
Horizon	Depth	Dominant Color Munsell	Redox Description Qu. Az. Cont. Color	Texture	Structure Gr. Sz. Sh.	Consistence	Boundary	Roots	GP	D/Ft <sup>2</sup>			
	In.								*Eff#1	*Eff#2			
1	0-9	10YR 3/3	none	sil	2msbk	mfr	cs	3m	0.6	0.8			
2	9-28	10YR 4/3	none	scl	2msbk	mfr	cs	2m	0.4	0.6			
3	28-40	7.5YR 4/4	none	sci	2msbk	mfr	cw	2m	0.4	0.6			
4	40-94	10YR 6/4	none	sl	1mpl	mfr		12"1f	0.4	0.6			

Boring #

Boring

Ground surface elev. \_\_\_\_\_ ft.

Depth to limiting factor \_\_\_\_\_ in.

							Soil Application Rate			
Horizon	Depth	Dominant Color	Redox Description	Texture	Structure	Consistence	Boundary	Roots	GPD	D/Ft <sup>2</sup>
	In.	Munsell	Qu. Az. Cont. Color		Gr. Sz. Sh.				*Eff#1	*Eff#2
								ļ		
		·								

\* Effluent #1 = BOD, > 30  $\leq$  220 mg/L and TSS > 30  $\leq$  150 mg/L

\* Effluent #2 = BOD, >  $30 \le 220$  mg/L and TSS >  $30 \le 150$  mg/L

PAGE 2 OF 6

